



BEFORE YOU DIG, DRILL OR BLAST!

CALL US TOLL FREE

1-800-962-7962 NY INDUSTRIAL CODE RULE 753 REQUIRES NO LESS

THAN
TWO WORKINGDAYS NOTICE, BUT NOT MORE THAN
TEN DAYS NOTICE.

UNAUTHORIZED ALTERATION OR ADDITION TO THIS DRAWING IS A VIOLATION OF SECTION 1209 (2) OF

THE NYS EDUCATION LAW.

THIS DRAWING IS ONE IN A SET OF DRAWINGS AND IS INCOMPLETE AND INVALID WHEN IT IS SEPARATED FROM THE SET.

Ø7/3Ø/21	SUBMIT FOR SIGNATURE	$\overline{}$
11/10/20	REVISION PER COMMENTS	
10/02/20	SUBMIT FOR SIGNATURE	
07/10/18	REVISION PER PLANNING BOARD COMMENTS	
05/08/18	REVISION PER PLANNING BOARD COMMENTS	
04/10/18	Date of Origin	
Date	Description	

# ESPOSITO & ASSOCIATES

262 GREENWICH AVENUE GOSHEN NY, 10924 845-294-0558 Fax 845-294-0580



ARCHITECT

ONE POLICE DRIVE WAREHOUSE


VILLAGE OF GOSHEN
TAX MAP: SEC. 122, BLK. 1, LOT 10.2

EXISTING CONDITIONS
PLAN

DRAWING TITLE

Unauthorized alteration or addition to a plan bearing a Licensed Land Surveyor's or Professional Engineer's seal is a violation of section 7209, subdivision 2 of the NY State Educational Law.

Scale:	Drawing No.:	Project No.:
1"=3Ø'	3 of 13	218Ø2.Ø1
CAD Reference:	O.C.H.D. Sheet No.:	D.E.C. Sheet No
	of of	Of

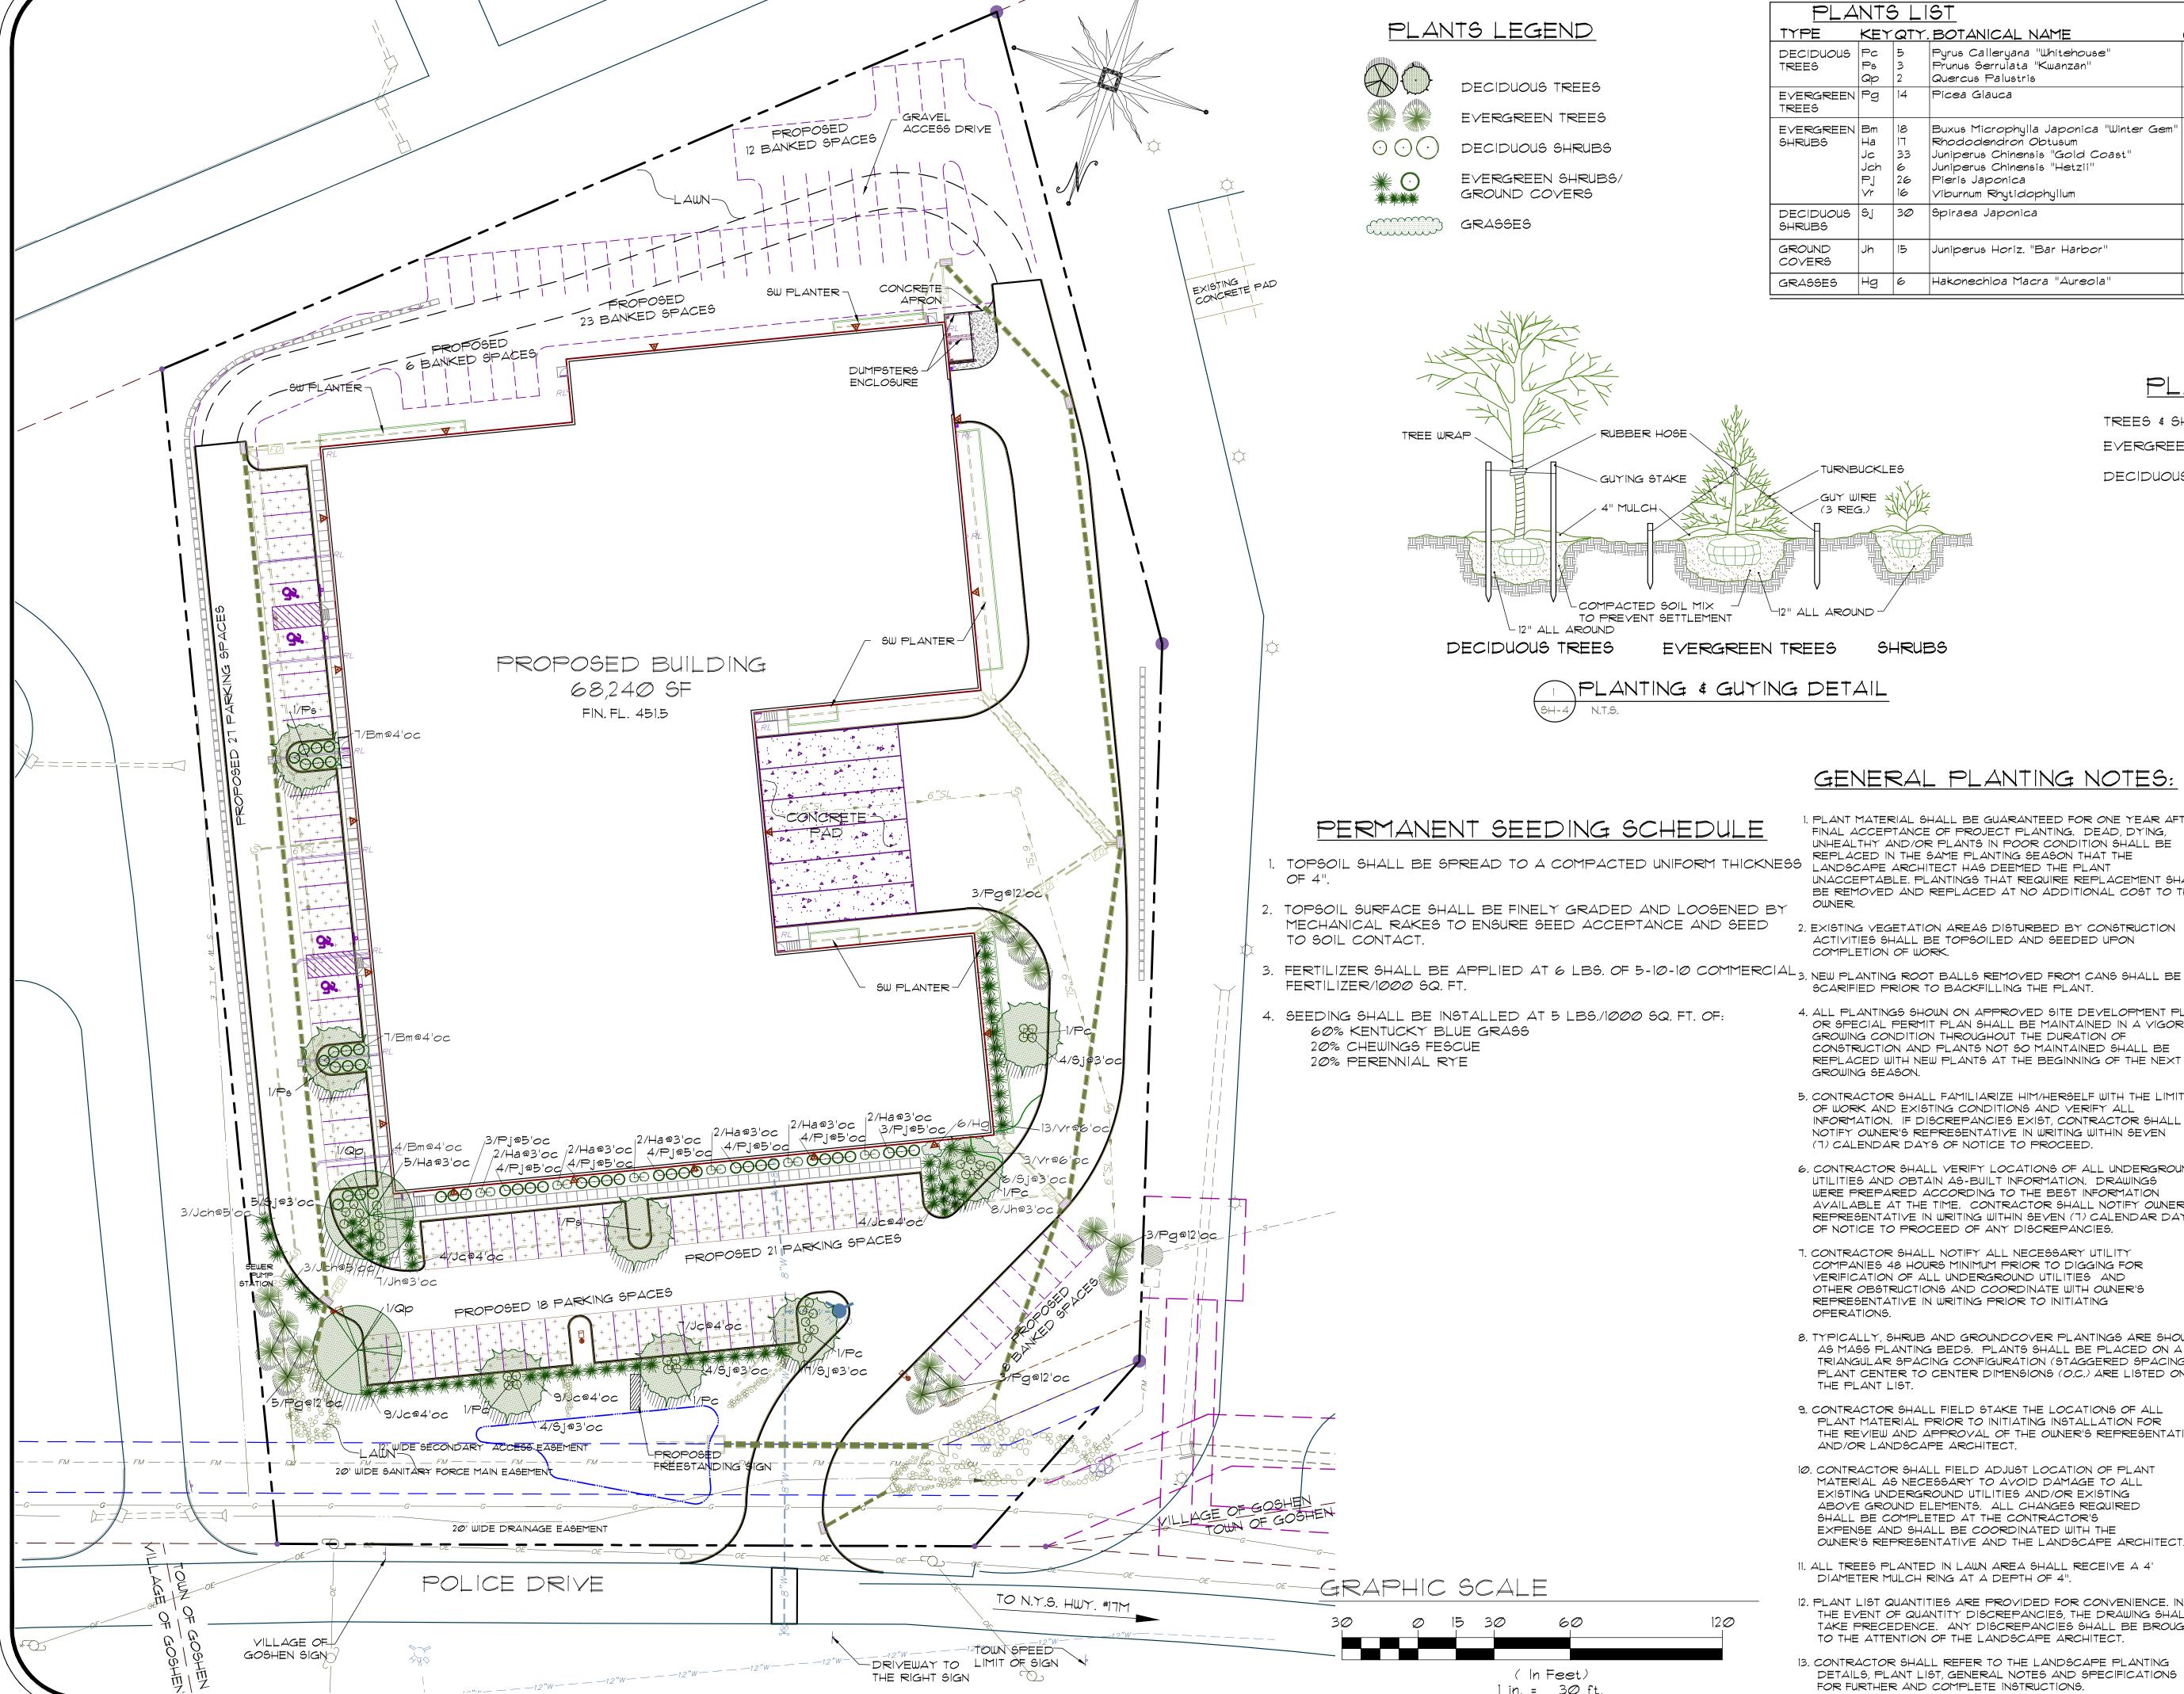

PLANTS LIST KEYQTY, BOTANICAL NAME COMMON NAME REMARKS SIZE 2-1/2"-3" c B\$B Pyrus Calleryana "Whitehouse" Whitehouse Callery Pear Prunus Serrulata "Kwanzan" Kwanzan Cherry 2-1/2"-3" c |B\$B TREES Pin Oak 3"-3-1/2" c | B\$B Quercus Palustris '-8'hgt | B&B White Spruce EVERGREEN Pg | 14 Buxus Microphylla Japonica "Winter Gem 30"-34" EVERGREEN Bm "|Winter Gem Boxwood Container 30"-34" Rhododendron Obtusum Container Hiryu Azalea 30"-34" Juniperus Chinensis "Gold Coast" Gold Coast Juniper Container Juniperus Chinensis "Hetzii' 40"-44" Hetzii Juniper Container 30"-36" B&B Pieris Japonica Japanese Andromeda 34"-36" BŧB Leatherleaf Viburnum Viburnum Rhytidophyllum 24"-30" Container Spiraea Japonica \_ittle Princess Spiraea DECIDUOUS Sj SHRUBS GROUND |Juniperus Horiz. "Bar Harbor" Container |Bar Harbor Juniper 2 gal. COVERS |Hakonechioa Macra "Aureola' |Golden Variegated Hakone Grass|8" oc

TURNBUCKLES

GENERAL PLANTING NOTES:

FINAL ACCEPTANCE OF PROJECT PLANTING. DEAD, DYING,

UNHEALTHY AND/OR PLANTS IN POOR CONDITION SHALL BE

2. EXISTING VEGETATION AREAS DISTURBED BY CONSTRUCTION

4. ALL PLANTINGS SHOWN ON APPROVED SITE DEVELOPMENT PLAN

CONSTRUCTION AND PLANTS NOT SO MAINTAINED SHALL BE

5. CONTRACTOR SHALL FAMILIARIZE HIM/HERSELF WITH THE LIMITS

INFORMATION. IF DISCREPANCIES EXIST, CONTRACTOR SHALL

6. CONTRACTOR SHALL VERIFY LOCATIONS OF ALL UNDERGROUND

REPRESENTATIVE IN WRITING WITHIN SEVEN (1) CALENDAR DAYS

NOTIFY OWNER'S REPRESENTATIVE IN WRITING WITHIN SEVEN

UTILITIES AND OBTAIN AS-BUILT INFORMATION. DRAWINGS

WERE PREPARED ACCORDING TO THE BEST INFORMATION AVAILABLE AT THE TIME. CONTRACTOR SHALL NOTIFY OWNER'S

REPLACED WITH NEW PLANTS AT THE BEGINNING OF THE NEXT

ACTIVITIES SHALL BE TOPSOILED AND SEEDED UPON

GROWING CONDITION THROUGHOUT THE DURATION OF

OF WORK AND EXISTING CONDITIONS AND VERIFY ALL

(1) CALENDAR DAYS OF NOTICE TO PROCEED.

OF NOTICE TO PROCEED OF ANY DISCREPANCIES.

T. CONTRACTOR SHALL NOTIFY ALL NECESSARY UTILITY COMPANIES 48 HOURS MINIMUM PRIOR TO DIGGING FOR VERIFICATION OF ALL UNDERGROUND UTILITIES AND

OTHER OBSTRUCTIONS AND COORDINATE WITH OWNER'S REPRESENTATIVE IN WRITING PRIOR TO INITIATING

9. CONTRACTOR SHALL FIELD STAKE THE LOCATIONS OF ALL

10. CONTRACTOR SHALL FIELD ADJUST LOCATION OF PLANT

EXISTING UNDERGROUND UTILITIES AND/OR EXISTING ABOVE GROUND ELEMENTS. ALL CHANGES REQUIRED

II. ALL TREES PLANTED IN LAWN AREA SHALL RECEIVE A 4'

SHALL BE COMPLETED AT THE CONTRACTOR'S

DIAMETER MULCH RING AT A DEPTH OF 4".

EXPENSE AND SHALL BE COORDINATED WITH THE

MATERIAL AS NECESSARY TO AVOID DAMAGE TO ALL

PLANT MATERIAL PRIOR TO INITIATING INSTALLATION FOR

8. TYPICALLY, SHRUB AND GROUNDCOVER PLANTINGS ARE SHOWN AS MASS PLANTING BEDS. PLANTS SHALL BE PLACED ON A

TRIANGULAR SPACING CONFIGURATION (STAGGERED SPACING).

THE REVIEW AND APPROVAL OF THE OWNER'S REPRESENTATIVE

OWNER'S REPRESENTATIVE AND THE LANDSCAPE ARCHITECT.

PLANT CENTER TO CENTER DIMENSIONS (O.C.) ARE LISTED ON

SCARIFIED PRIOR TO BACKFILLING THE PLANT.

COMPLETION OF WORK.

GROWING SEASON

OPERATIONS.

THE PLANT LIST.

AND/OR LANDSCAPE ARCHITECT.

REPLACED IN THE SAME PLANTING SEASON THAT THE

LANDSCAPE ARCHITECT HAS DEEMED THE PLANT

PLANT MATERIAL SHALL BE GUARANTEED FOR ONE YEAR AFTER

UNACCEPTABLE. PLANTINGS THAT REQUIRE REPLACEMENT SHALL BE REMOVED AND REPLACED AT NO ADDITIONAL COST TO THE

JGUY WIRE (3 REG.)

### PLANTING SCHEDULE

SPRING PLANTING FALL PLANTING TREES & SHRUBS EVERGREEN APRIL 1 - JUNE 30 SEPT. 1 - OCT. 15

DECIDUOUS MARCH I - JUNE 30 OCT. 1 - DEC. 1



BEFORE YOU DIG, DRILL OR BLAST

CALL US TOLL FREE

1-800-962-7962 NY INDUSTRIAL CODE RULE 753 REQUIRES NO LESS

TWO WORKINGDAYS NOTICE, BUT NOT MORE THAN TEN DAYS NOTICE.

UNAUTHORIZED ALTERATION OR ADDITION TO THIS DRAWING IS A VIOLATION OF SECTION 7209 (2) OF THE NYS EDUCATION LAW.


THIS DRAWING IS ONE IN A SET OF DRAWINGS AND IS INCOMPLETE AND INVALID WHEN IT IS SEPARATED

SUBMIT FOR SIGNATURE 11/10/20 REVISION PER COMMENTS 10/02/20 SUBMIT FOR SIGNATURE REVISION PER PLANNING BOARD Ø7/1Ø/18 COMMENTS REVISION PER PLANNING BOARD 05/08/18 COMMENTS Date of Origin OR SPECIAL PERMIT PLAN SHALL BE MAINTAINED IN A VIGOROUS  $|\emptyset4/1\emptyset/18|$ 

# ESPOSITO & ASSOCIATES

Description

262 GREENWICH AVENUE GOSHEN NY, 10924 84<del>5294</del>@558 Fax 845.294.*0*58*0* 

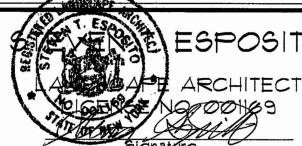

### ONE POLICE DRIVE WAREHOUSE

VILLAGE OF GOSHEN

TAX MAP: SEC. 122, BLK. 1, LOT 10.2


### LANDSCAPE PLAN AND DETAILS

DRAWING TITLE

Date

Unauthorized alteration or addition to a plan bearing a Licensed Land Surveyor's or Professional Engineer's seal is a violation of section 7209. subdivision 2 of the NY State Educational Law.

12. PLANT LIST QUANTITIES ARE PROVIDED FOR CONVENIENCE. IN THE EVENT OF QUANTITY DISCREPANCIES, THE DRAWING SHALL TAKE PRECEDENCE. ANY DISCREPANCIES SHALL BE BROUGHT TO THE ATTENTION OF THE LANDSCAPE ARCHITECT.	Scale:	Drawing No.:	Project No.:
	1"=3Ø'	4 of 13	21802.01
13. CONTRACTOR SHALL REFER TO THE LANDSCAPE PLANTING DETAILS, PLANT LIST, GENERAL NOTES AND SPECIFICATIONS FOR FURTHER AND COMPLETE INSTRUCTIONS.	CAD Reference: .dwg	O.C.H.D. Sheet No.: of	D.E.C. Sheet No,: of

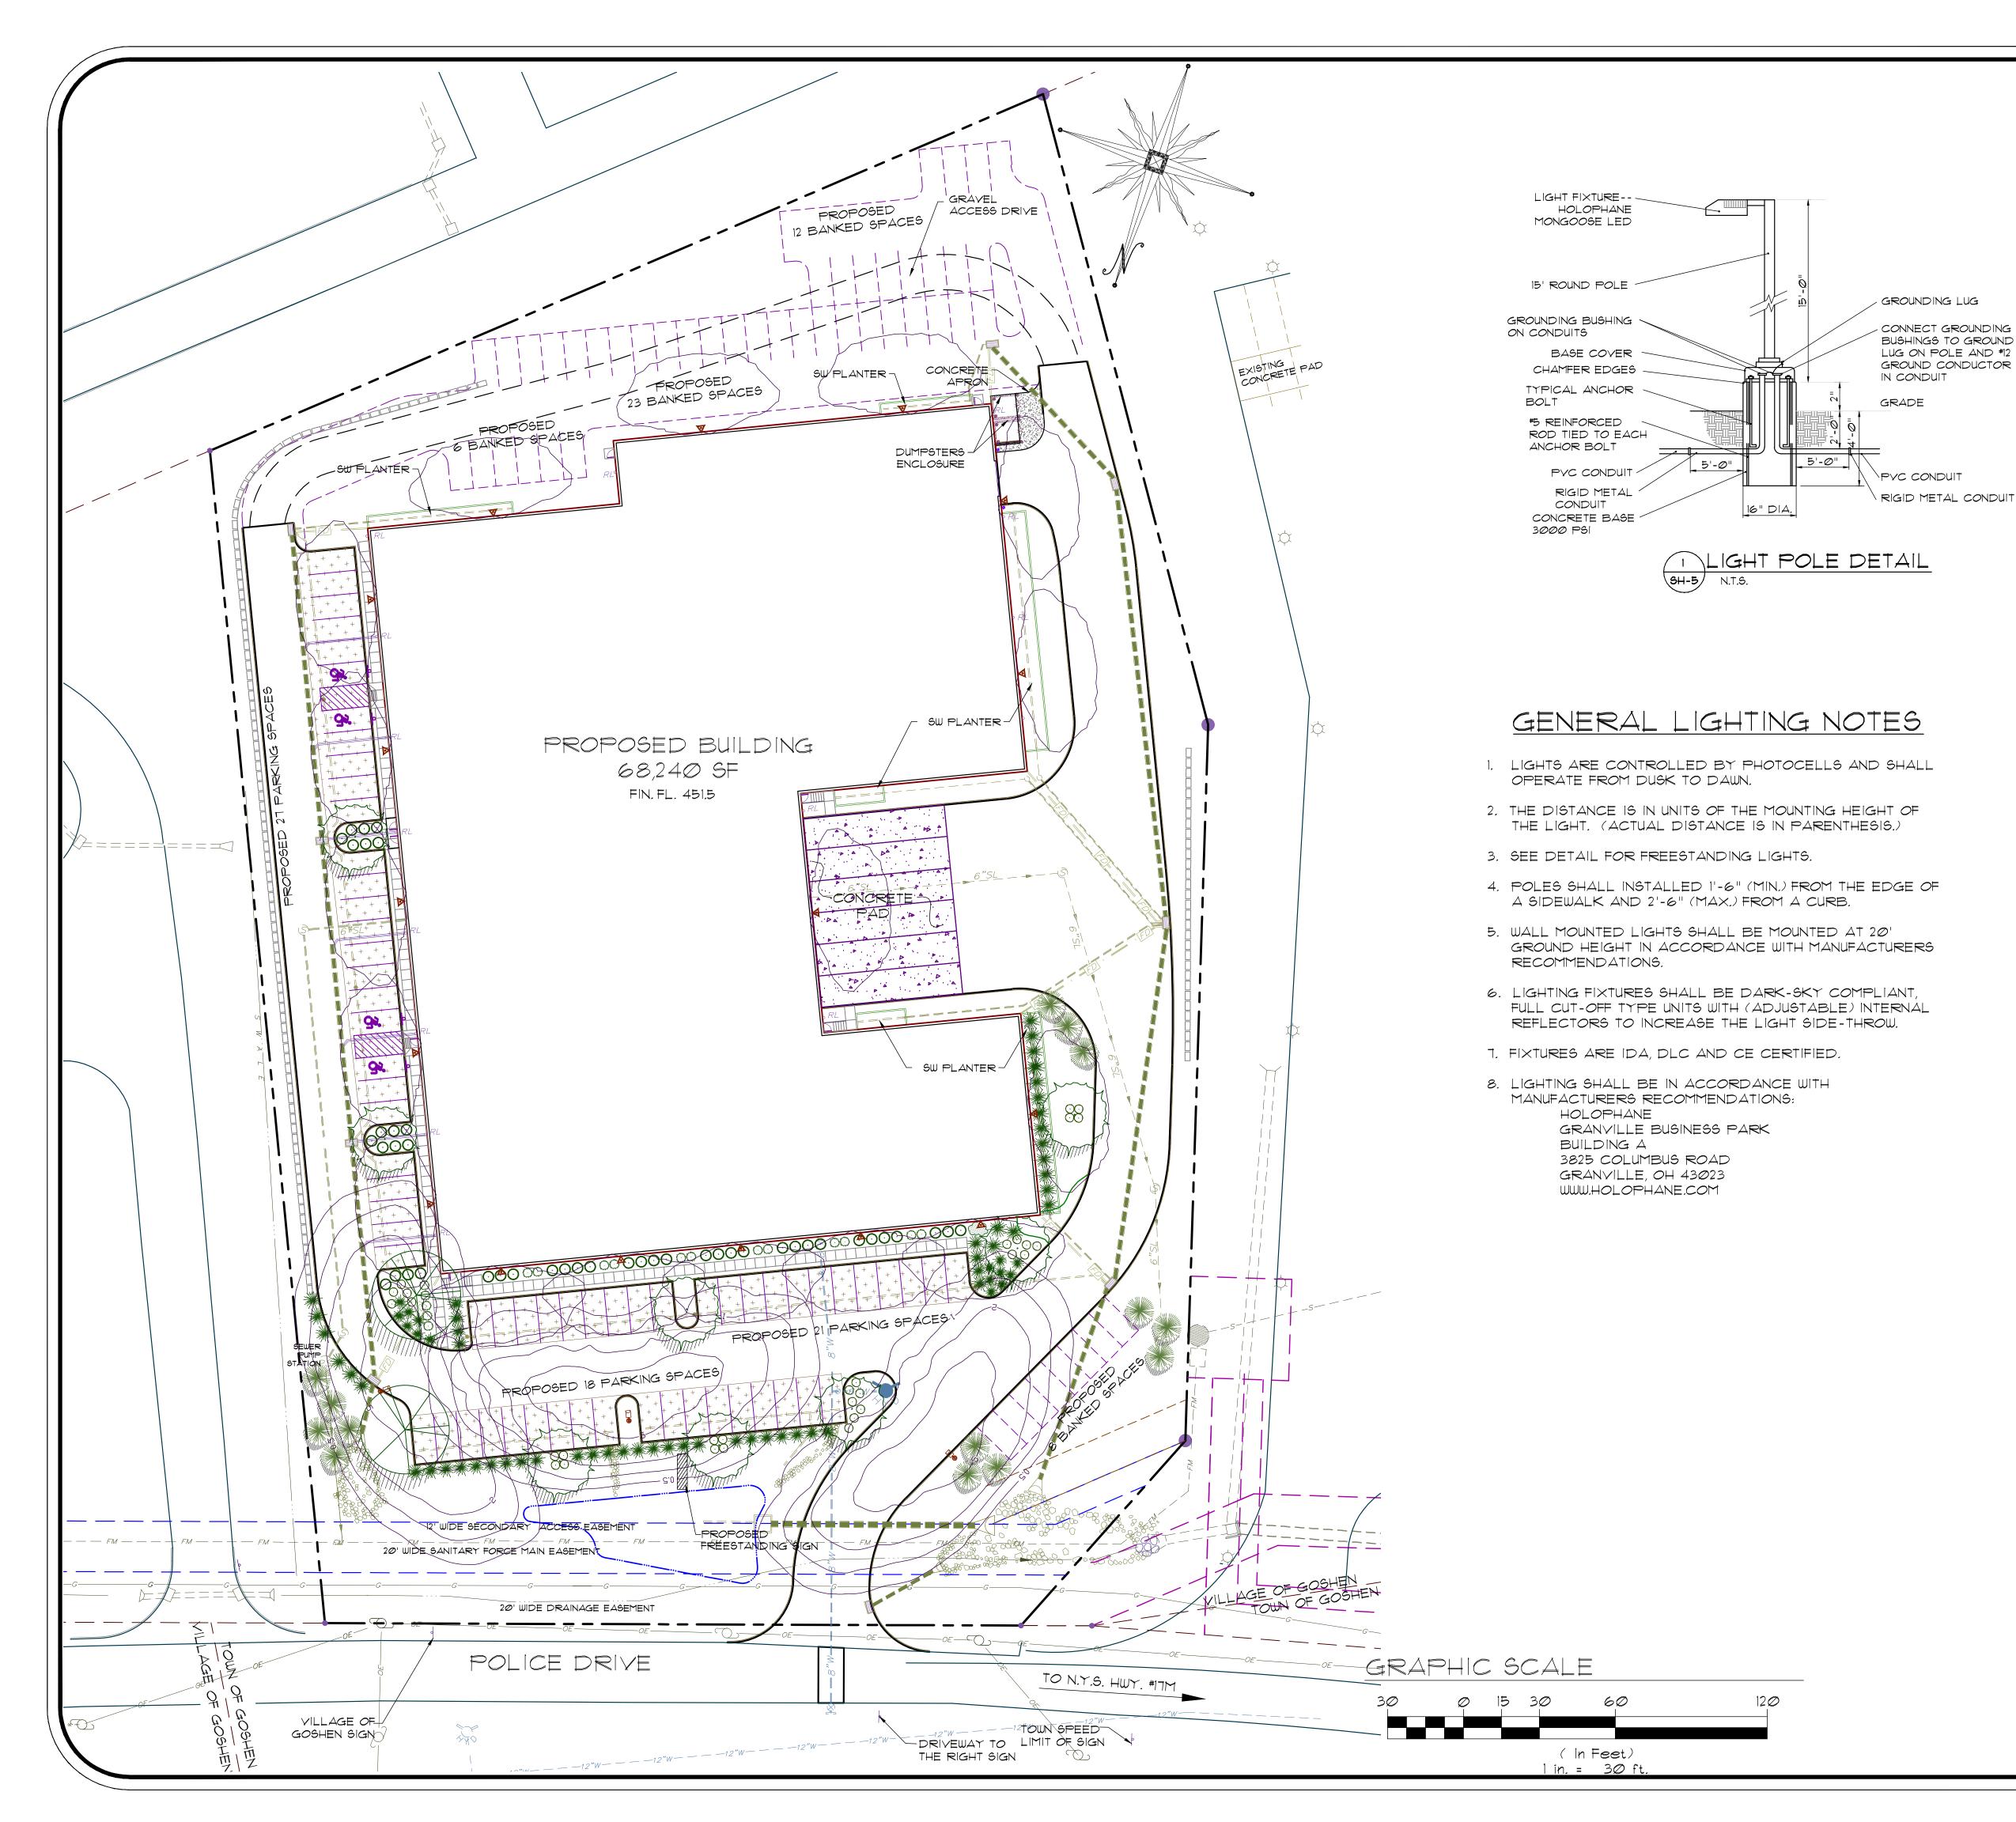

### LIGHTING LEGEND


WALL MOUNT LIGHT
W4P LED 30C 700 40K T3M



W4P LED, 30LED'S 700mA DRIVER, 4000K CCT, TYPE 3 OPTIC, AND REFLECTOR

FREESTANDING LIGHTS

MGLED 7 4K AX M L XX

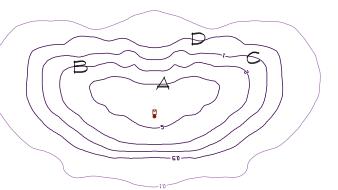

MONGOOSE LED WITH I COBS, 4000K COLOR TEMPERATURE, 1050mA DRIVE CURRENT, TYPE M LENS (MEDIUM), LOW TILT.

### PHOTOMETRICS

- A = 5.00 FOOT CANDLE
- B = 2.00 FOOT CANDLE
- C = 1.00 FOOT CANDLE D = 0.50 FOOT CANDLE

97/30/21 SUBMIT FOR SIGNATURE
11/10/20 REVISION PER COMMENTS

SUBMIT FOR SIGNATURE

OT/10/18

REVISION PER PLANNING BOARD
COMMENTS

O5/08/18

REVISION PER PLANNING BOARD
COMMENTS

O4/10/18

Date of Origin

### ESPOSITO & ASSOCIATES

Description

262 GREENWICH AVENUE GOSHEN NY, 10924 845-234-0558 Fax 845.294.0580



ARCHITECT

NO DONES

# ONE POLICE DRIVE WAREHOUSE

VILLAGE OF GOSHEN

TAX MAP: SEC. 122, BLK. 1, LOT 10.2


LIGHTING PLAN AND DETAILS

### DRAWING TITLE:

Date

Unauthorized alteration or addition to a plan bearing a Licensed Land Surveyor's or Professional Engineer's seal is a violation of section 7209, subdivision 2 of the NY State Educational Law.


Scale:	Drawing No.:	Project No.:
1"=3Ø'	5 of 13	21802.01
CAD Reference:	O.C.H.D. Sheet No	.: D.E.C. Sheet N
.dwg	of .	of

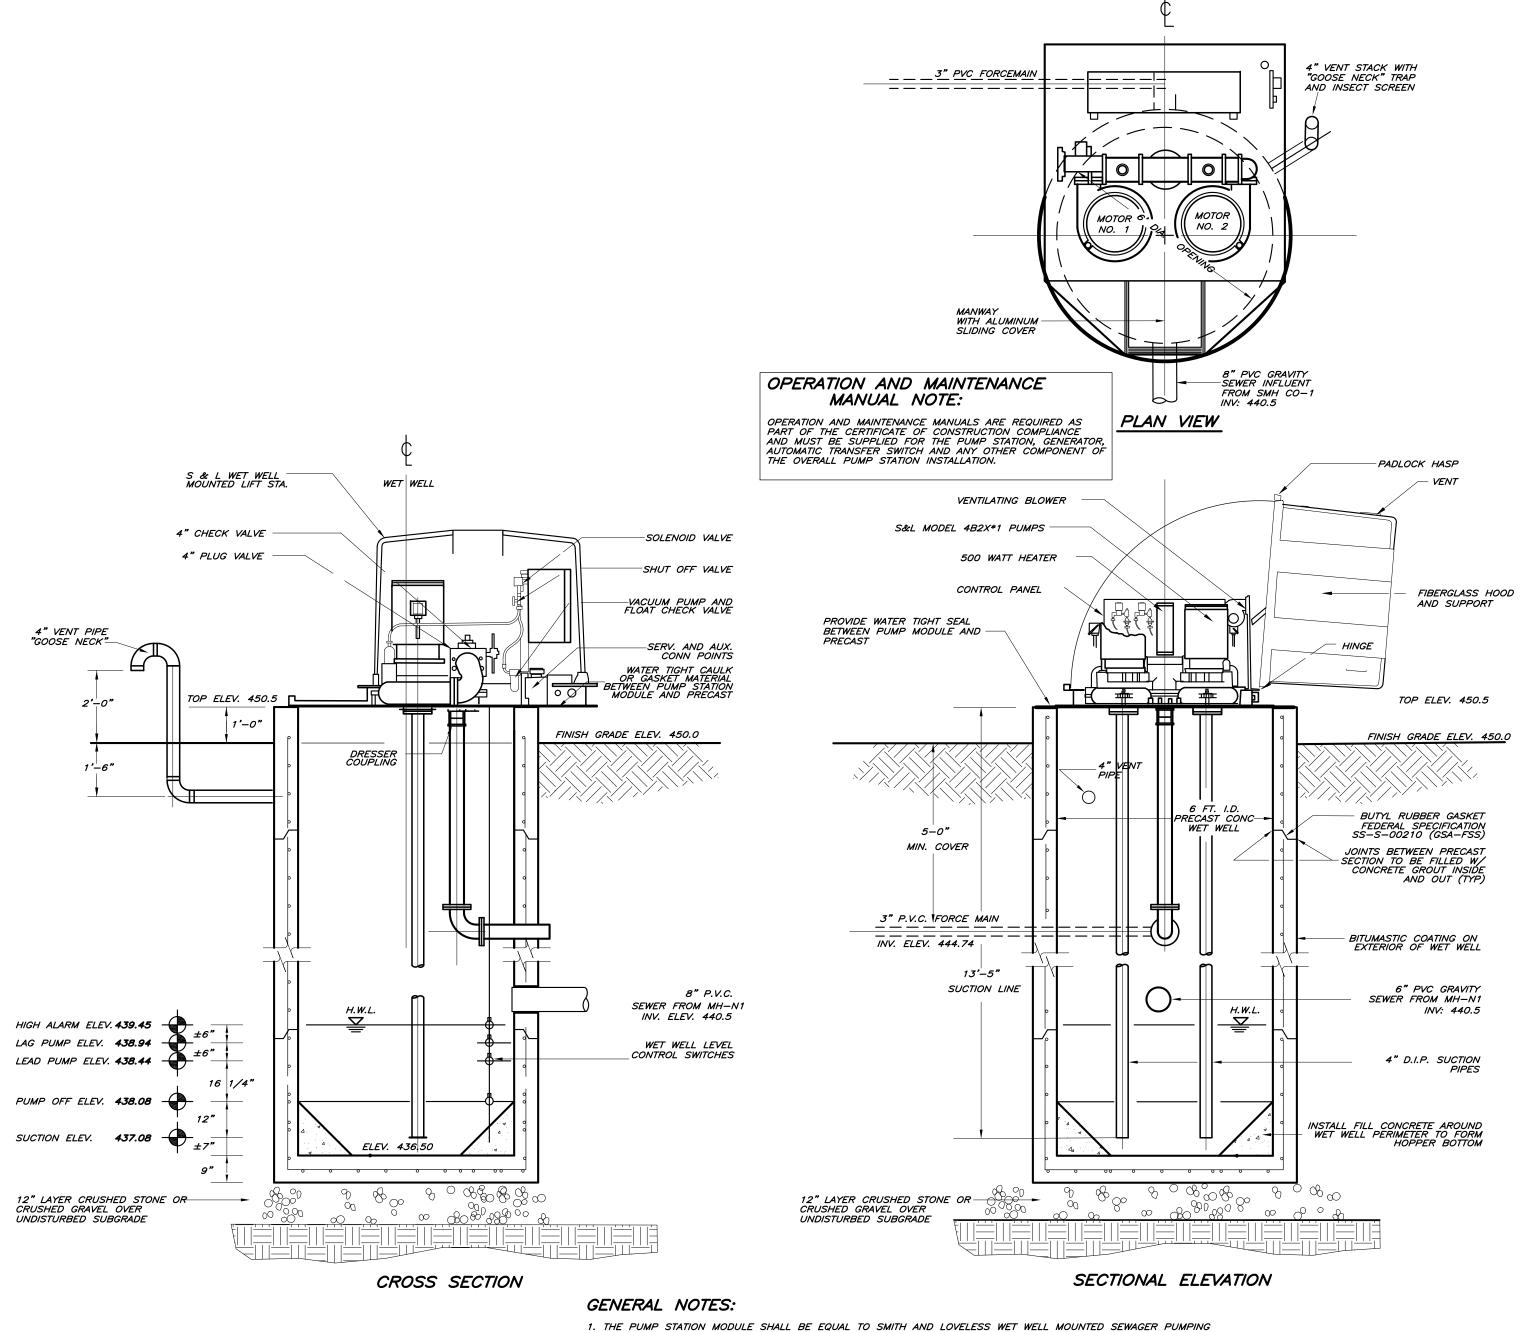

1. THE PUMP STATION MODULE SHALL BE EQUAL TO SMITH AND LOVELESS WET WELL MOUNTED SEWAGER PUMPING STATION, MEETING THE DIMENSIONS SHOWN HEREON.


2. SEE SEPARATE ELECTRICAL DRAWINGS FOR POWER CONNECTIONS TO THIS PUMP STATION SITE. ELECTRICAL WORK SHALL COMPLY THE REQUIREMENTS OF THE NEC.

(A ) SANITARY SEWER PUMP STATION SCALE: 3/8" = 1'-0"

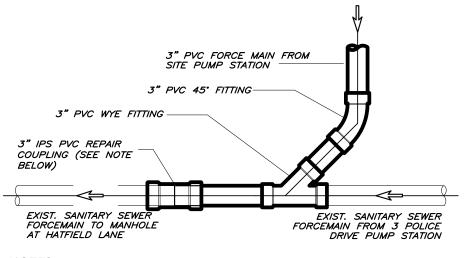

EXISTING SANITARY SEWER FORCEMAIN IS ACTIVE. INSTALLATION OF NEW FORCEMAIN CONNECTION REQUIRES TEMPORARY SUSPENSION OF EXISTING OPERATION.
 COMPONENTS OF EXISTING AND PROPOSED FORCEMAIN ARE SCH 80 PVC. INSTALLATION CONTRACTOR SHALL EXPOSE EXISTING FORCEMAIN AT THE TIE—IN LOCATION AND VERIFY EXISTING PIPE SIZE AND MATERIALZ E .
 3. 3 INCH PVC REPAIR COUPLING SHALL BE EQUAL TO "HARCO KNOCK—ON" REPAIR COUPLING (PART NO. 109—030) WITH A PRESSURE RATING OF 200 PSI

B SEWER FORCE MAIN TIE-IN DETAIL SCALE: 1" = 1'-0"

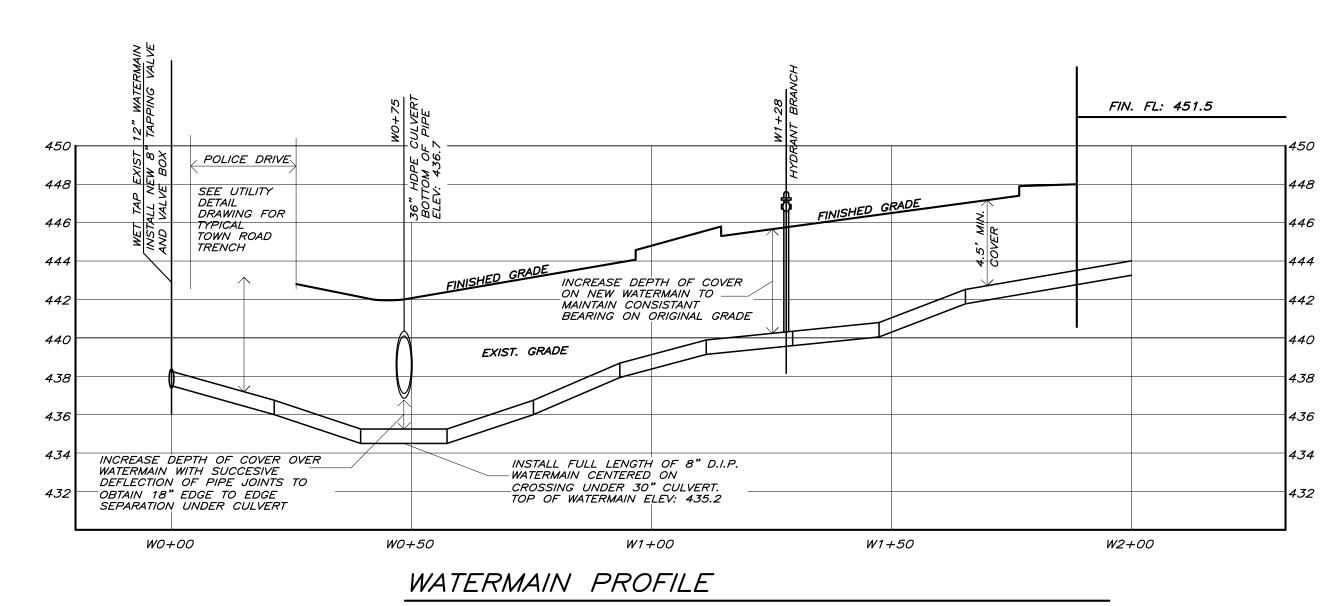

HORIZ. SCALE: 1"=20 VERT. SCALE: 1"=5

7/30/21	FORCEMAIN TIE-IN, SUBMIT FOR SIGNATURE
11/10/20	SUBMIT FOR SIGNATURE
10/02/20	5&L PUMP MODEL NO. UPSIZE FORCEMAIN TO 3"
7/10/2018	CHANGE SET OF DRAWINGS TO 13
4/10/2018	Date of Origin
Date	Description

## ESPOSITO & ASSOCIATES

262 GREENWICH AVENUE GOSHEN NY, 10924 845,294,0558 Fax 845,294,0580




VILLAGE OF GOSHEN


TAX MAP: SEC. 122, BLK. 1, LOT 10.2

SANITARY SEWER PUMP STATION AND UTILITY PROFILES


Unauthorized alteration or addition to a plan bearing a Licensed Land Surveyor's or Professional Engineer's seal is a violation of section 7209, subdivision 2 of the NY State Educational Law.

Scale:	Drawing No.;	Project No.;
AS NOTED	6 of 13	2 508,0  03008
CAD Reference:	O.C.H.D. Sheet No.:	SWPPP Sheet No.:
iggl(03007R-PUMPSTA	of of	of
V03007R-PUMPSTA	of	

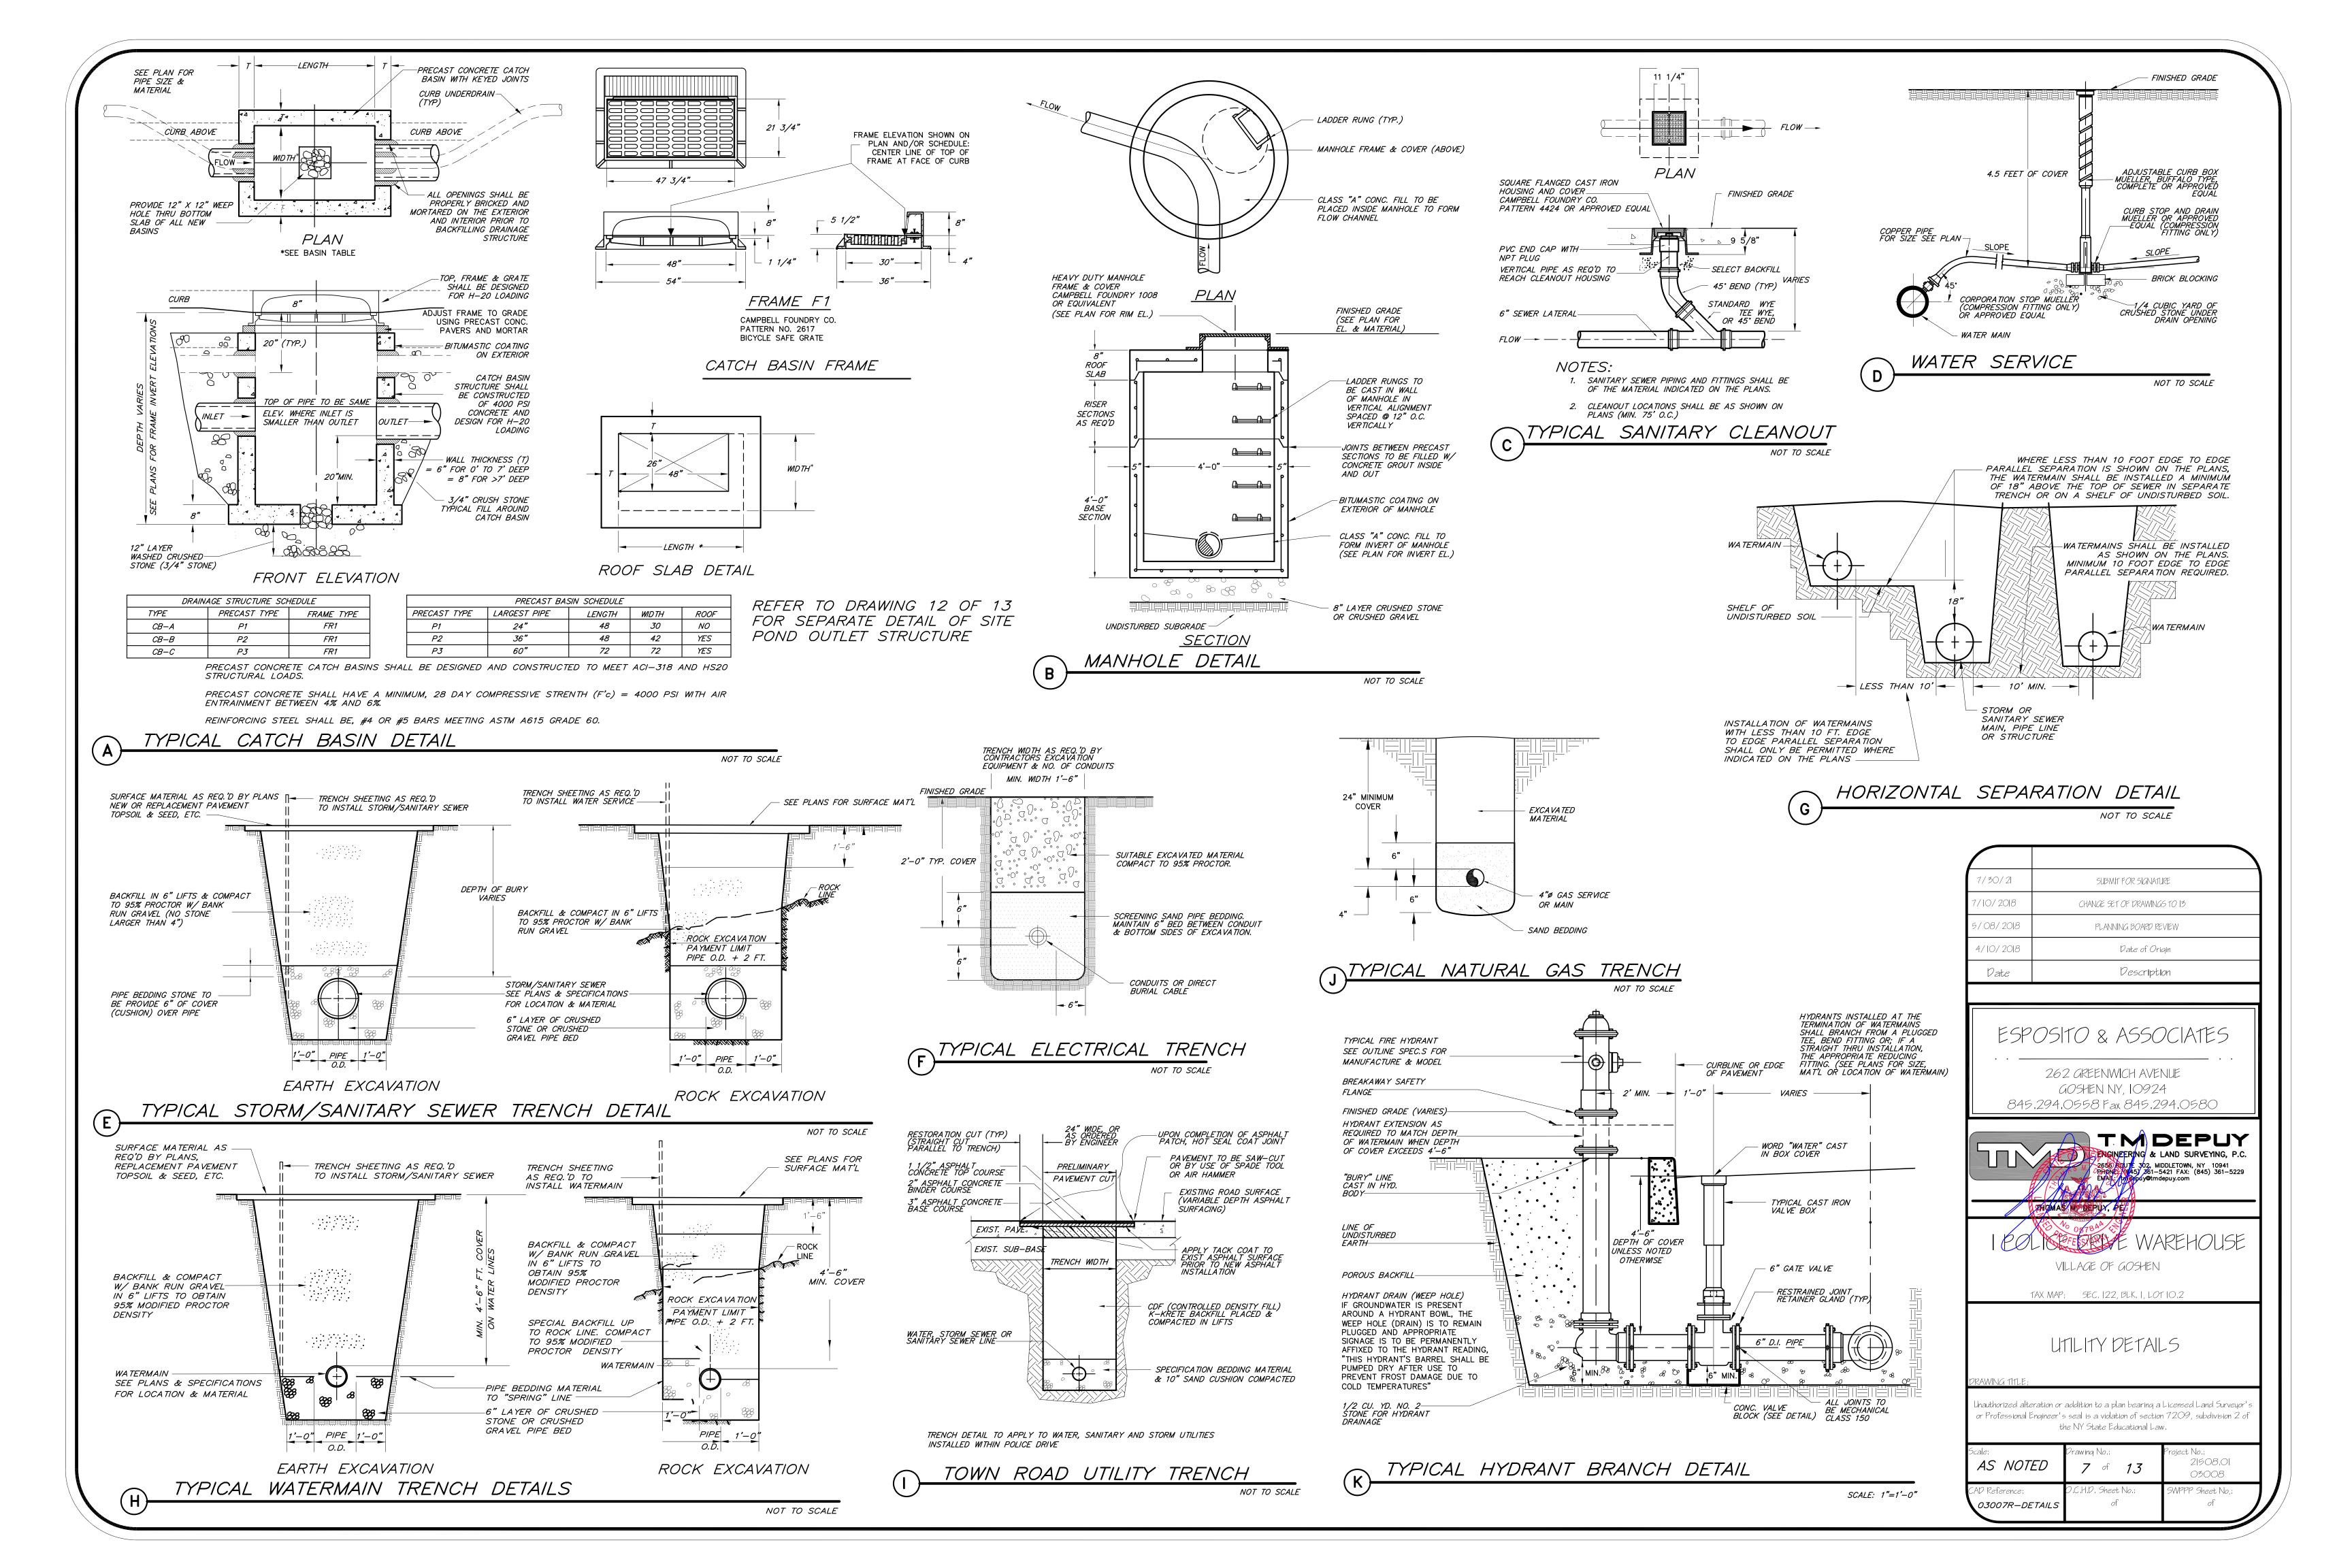

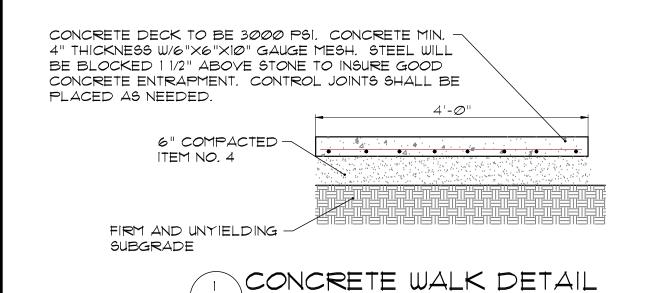

SH-8 N.T.S.

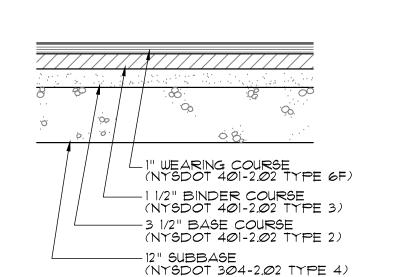

TYPE "A" PAVING DETAIL


\_YAN ACCESSIBLE SIGN

WHERE APPLICABLE


-SIGN SHALL BE MOUNTED ON POST @ 6'-0" ABOVE

GRADE

CURB SHALL BE CAST IN PLACE. EXPANSION JOINTS OF 3/16" CELLULOSE OR SIMILAR MATERIAL SHALL BE PLACED AT TEN (10) FOOT INTERVALS. CONCRETE TO 6" BE 1:2:3 MIX DESIGN, AIR ENTRAINED WITH DUREX OR EQUAL.

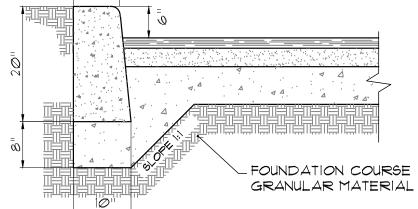

CONCRETE CURB DETAIL

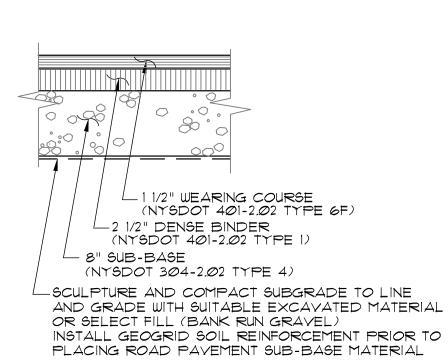

POROUS PAVEMENT SECTION SHALL BE INSTALLED TOWARDS THE END OF THE CONSTRUCTION PERIOD. TYPE "B" PAVING DETAIL

N.T.S.

SUBSURFACE AREA SHALL BE EXCAYATED TO THE PROPOSED DEPTH, AND SUBGRADE SHALL NOT BE COMPACTED OR SUBJECT TO EXCESSIVE CONSTRUCTION EQUIPMENT LOADS PRIOR TO PLACEMENT OF GEOTEXTILE.

ON BOTTOM AND SIDE OF

EXCAVATION AS SHOWN

INSTALL APPROVED GEOTEXTILE

SEE PLAN FOR DRIVE WIDTH

TO SEND SOME

TYPICAL PAVEMENT SECTION (SEE SEPARATE DETAIL)

(SH-8/

\_6" SURFACE LAYER OF CRUSHED STONE OR SHALE

GRAVEL DRIVE DETAIL

SCULPTURE SUBGRADE TO REFLECT FINAL GRADES AND COMPACT SAME TO PROVIDE STABILIZED DRAINAGE

OF BOTH SUBGRADE AND SURFACE

PERVIOUS PAVEMENT: 5 ½" POROUS ASPHALT (3 LIFTS @ 2" EA. MAX)

-8" CHOKER COURSE: (AASHTO#57)

-6" PERF, PVC UNDERDRAIN PIPE

\_12" UNDERDRAIN (STORAGE) LAYER

WASHED, CLEAN OF FINES)

\_8" FILTER LAYER: \*2 ( $\frac{2}{4}$ ") STONE (DOUBLE)

-3" DRAINAGE LAYER: PEA (है") GRAVEL


SPACE AT 20' O.C.:SLOPE AT 0.5% (MIN)

3. BOTTOM OF SECTION TO BE AT LEVEL GRADE.

4. PLACE GEOTEXTILE AND UNDERDRAIN AGGREGATE IMMEDIATELY AFTER APPROVAL OF THE SUBGRADE PREPARATION TO PREVENT ACCUMLALTION OF DEBRIS OR SEDIMENT.

5. PREVENT SURFACE RUNOFF FROM ENTERING THE STORAGE (UNDERDRAIN) BED DURING PLACEMENT OF GEOTEXTILE AND AGGREGATE.



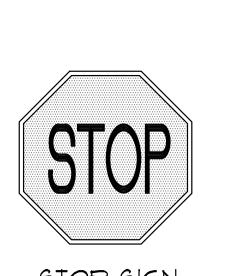

\sH-8/

N.T.S.

STOP SIGN NYSMUTCD RI-1C (30x30)

6H-8/ N.T.S.



NO PARKING SIGN


# HANDICAP SIGN

12"


HANDICAF PARKING BY PERMIT ONLY


TOW-AWAY ZONE


VAN ACCESSIBLE

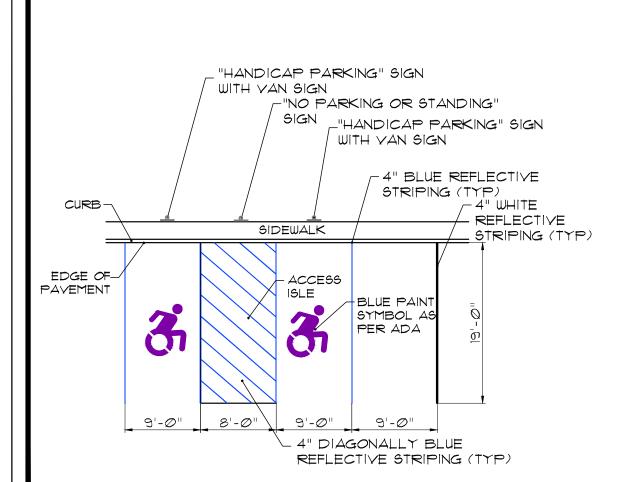


9 PARKING SPACE STRIPING DETAIL (SH-8) N.T.S.

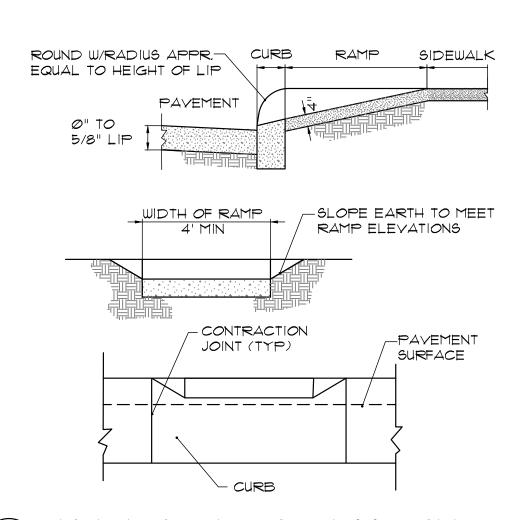


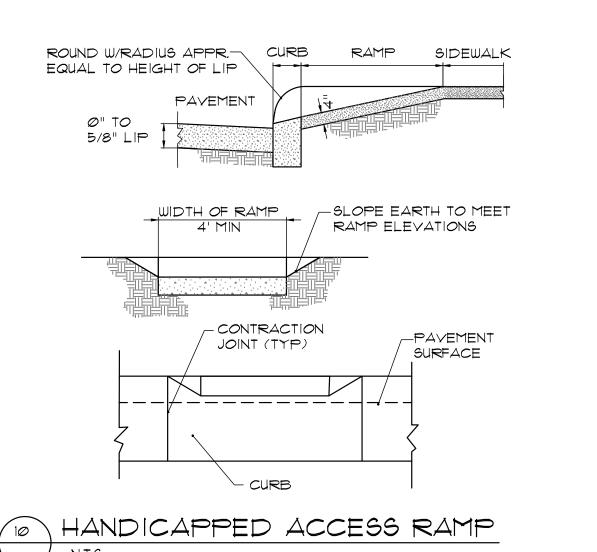

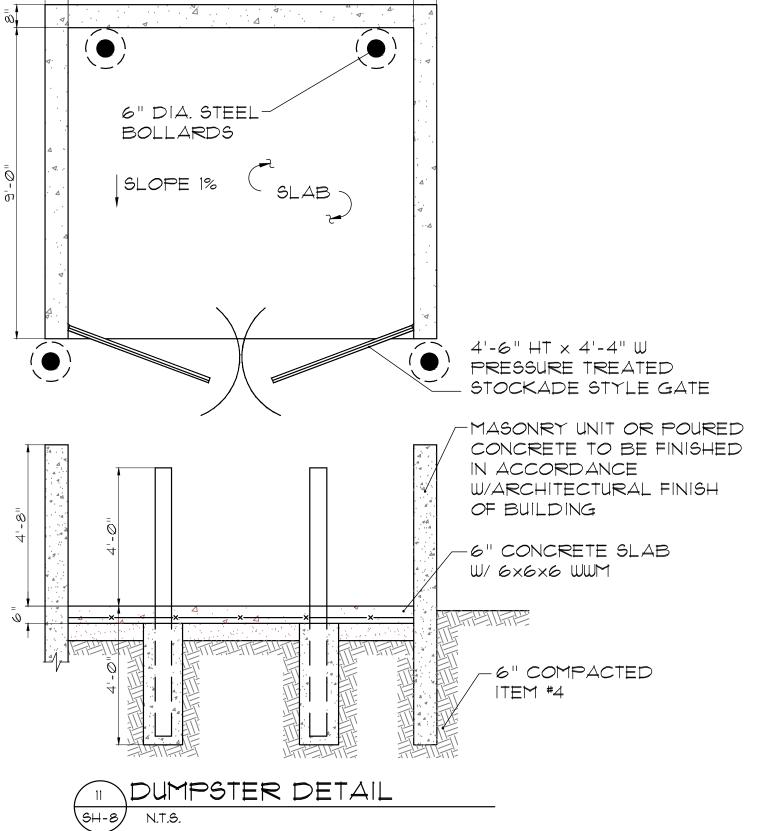


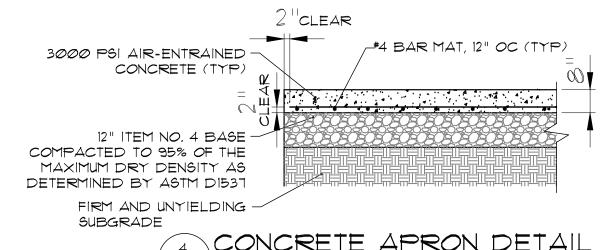

4 CONCRETE APRON DETAIL SH-8/ N.T.S.

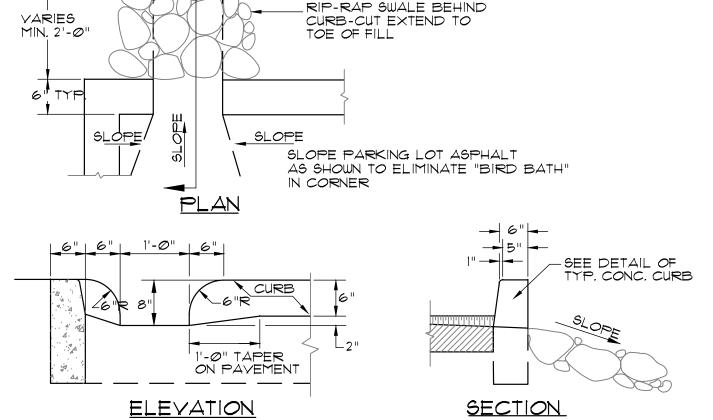

DRAINAGE CURB CUT DETAIL N.T.S.

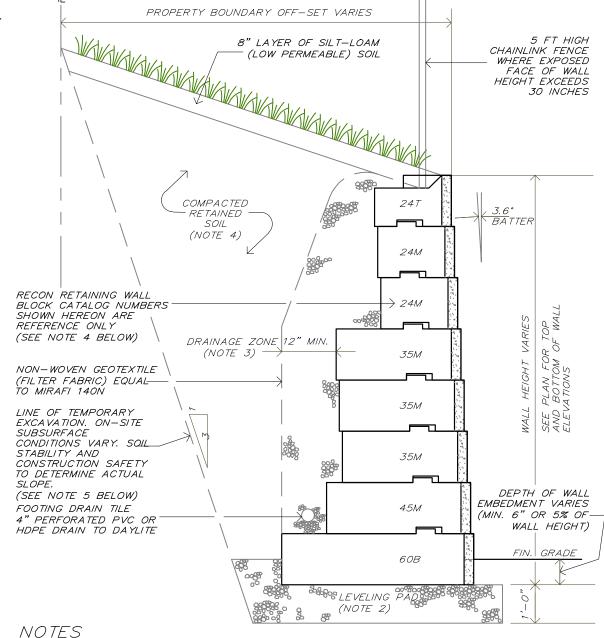

### NOTES

- 1. UNIT BLOCK RETAINING WALL SHALL BE EQUAL TO RECON RETAINING WALL SYSTEMS. SYSTEM INSTALLATION SHALL BE IN ACCORDANCE WITH WALL SYSTEM MANUFACTURERS RECOMMENDATIONS. 2. RETAINING WALL FOUNDATION LEVELING PAD SHALL BE NON-REINFORCED CONCRETE (F'c=3000PSI) OR COMPACTED CRUSHED 3" STONE. FOUNDATION SUBGRADE SOILS SHALL BE CAPABLE OF SUPPORTING WALL SYSTEM (MIN. 1.5 TONS PER SQUARE FOOT BEARING CAPACITY).
- 3. DRAINAGE ZONE MATERIAL SHALL BE CLEAN \( \frac{3}{4} \) CRUSHED STONE OR CRUSHED GRAVEL.
- 4. NON-STRUCTURAL FILL (RETAINED SOIL) SHALL BE NATIVE SOIL COMPACTED TO 95% MODIFIED PROCTOR DENSITY.

5. CONTRACTOR SHALL PROVIDE DETAILED DESIGN DRAWINGS OF ENTIRE RETAINING WALL FOR PRIOR APPROVAL OF THE MUNICIPAL ENGINEER PRIOR TO ARRIVALOF WALL COMPONENTS AT THE

6. SUBGRADE SOILS ON THIS SITE ARE PRESUMED TO BE SHALE ROCK FOR THE EXTENT OF THE PROPOSED RETAINING WALL LOCATION. FIELD VERIFICATION IS NECESSARY TO DETERMINE ACTUAL BEARING CAPACITY AND SAFE EXCAVATION SLOPE LIMITS.

### TYPICAL GRAVITY RETAINING WALL DETAIL N.T.S.

### RETAINING WALL NOTE:

DETAILED DESIGN OF UNIT BLOCK RETAINING WALL BY WALL SYSTEM MANUFACTURER SHALL BE SUBMITTED BY THE SITE CONTRACTOR TO THE VILLAGE OF GOSHEN BUILDING DEPARTMENT TO OBTAIN A BUILDING PERMIT. SUBMITTALS SHALL BE SIGNED AND SEALED BY A NYS LICENSED PROFESSIONAL ENGINEER.

Ø7/3Ø/21	SUBMIT FOR SIGNATURE	\
11/10/20	REVISION PER COMMENTS	
10/02/20	SUBMIT FOR SIGNATURE	
07/10/18	REVISION PER PLANNING BOARD COMMENTS	
Ø5/Ø8/18	REVISION PER PLANNING BOARD COMMENTS	
04/10/18	Date of Origin	
Date	Description	



## ONE POLICE DRIVE WAREHOUSE

VILLAGE OF GOSHEN SEC. 122, BLK. 1, LOT 10.2 TAX MAP:

### SITE PLAN DETAILS

### DRAWING TITLE

Unauthorized alteration or addition to a plan bearing a Licensed Land Surveyor's or Professional Engineer's seal is a violation of section 7209, subdivision 2 of the NY State Educational Law.

	Scale:	Drawing No.:	Project No.:	
_	1"=3Ø'	8 of 13	21802.01	
7				
	CAD Reference:	O.C.H.D. Sheet No.:	D.E.C. Sheet No,:	
	_dwg	Of	of /	
				_

### FOR ALL CONSTRUCTION ACTIVITIES SUBJECT TO THIS GENERAL PERMIT (GP-0-20-001) EFFECTIVE: JANUARY 29, 2020 EXPIRES: JANUARY 28, 2025

#### A. GENERAL

1. CONTRACTORS SHALL TAKE NOTICE THAT THE WATERS OF THE UNITED STATES ARE PROTECTED UNDER THE FEDERAL LAW KNOWN AS THE CLEAN WATER ACT ("CWA") STORM WATER DISCHARGES FROM CONSTRUCTION ACTIVITIES TO THE WATERS OF THE UNITED STATES ARE UNLAWFUL, UNLESS AUTHORIZED BY A NATIONAL POLLUTANT DISCHARGE ELIMINATION SYSTEM ("NPDES") PERMIT. THE NEW YORK STATE DEPARTMENT OF ENVIRONMENTAL CONSERVATION ("NYSDEC") ADMINISTERS THE STATE POLLUTANT DISCHARGE ELIMINATION SYSTEM ("SPDES") PERMIT PROGRAM, IN CONFORMANCE WITH THE FEDERAL STORM WATER (NPDES) REGULATIONS.

- OWNER OR OPERATOR MEANS THE PERSON, PERSONS OR LEGAL ENTITY WHICH OWNS OR LEASES THE PROPERTY ON WHICH THE CONSTRUCTION ACTIVITY IS OCCURRING: AND/OR AN ENTITY THAT HAS OPERATIONAL CONTROL OVER THE CONSTRUCTION PLANS AND SPECIFICATIONS, INCLUDING THE ABILITY TO MAKE MODIFICATIONS TO THE PLANS AND SPECIFICATIONS.
- 3. CONTRACTORS SHALL TAKE NOTICE THAT THE OWNER OR OPERATOR HAS FILED OR IS ABOUT TO FILE A NOTICE OF INTENT ("NOI") WITH THE NYSDEC, AND IS THE PERMITTEE REFERED TO HEREINAFTER. THIS "NOI" APPLICATION INCLUDES THE STORM WATER POLLUTION PREVENTION PLAN ("SWPPP") PREPARED FOR THIS SUBDIVISION, AND APPLIES TO THE PUBLIC IMPROVEMENTS INDICATED ON THE SUBDIVISION PLANS. THE ONTRACTOR SHALL SUBMITT A SEPARATE SOIL EROSION AND SEDIMENTATION CONTROL PLAN WITH EACH APPLICATION FOR A BUILDING PERMIT.
- 4. THE CONTRACTOR AND HIS/HER SUBCONTRACTORS ARE SUBJECT TO THE TERMS AND CONDITONS OF THE SPDES GENERAL PERMIT ISSUED TO THE **PERMITTEE** FOR THE CONSTRUCTION OF THIS RESIDENTIAL SUBDIVISION. WITHOUT LIMITING THE FOREGOING, SWPPP PROVIDES THE DETAILED INFORMATION FOR COMPLIANCE.
- PRIOR TO COMMENCEMENT OF CONSTRUCTION ACTIVITY, THE PERMITTEE MUST IDENTIFY THE CONTRACTOR(S) AND SUBCONTRACTOR(S) THAT WILL BE RESPONSIBLE FOR INSTALLING. CONSTRUCTING. REPAIRING. INSPECTING AND MAINTAINING THE EROSION AND SEDIMENT CONTROL PRACTICES INCLUDED IN THE SWPPP. AND THE CONTRACTOR(S) AND SUBCONTRACTOR(S) THAT WILL BE RESPONSIBLE FOR THE CONSTRUCTION OF ALL THE POST-CONSTRUCTIÓN MANAGEMENT PRACTICES INCLUDED IN THE SWPPP. THE PERMITTEE SHALL HAVE EACH OF THESE CONTRACTORS AND SUBCONTRACTORS IDENTIFY AT LEAST ONE TRAINED INDIVIDUAL FROM THE COMPANY THAT WILL BE RESPONSIBLE FOR IMPLEMENTATION OF THE SWPPP. THE **PERMITTEE** SHALL ENSURE THAT AT LEAST ONE TRAINED INDIVIDUAL IS ON SITE ON A DAILY BASIS WHEN SOIL DISTURBANCE ACTIVITIES ARE BEING PERFORMED.
- 6. THE OWNER OR OPERATOR OF A CONSTRUCTION ACTIVITY SHALL **NOT DISTURB GREATER** THAN FIVE (5) ACRES OF SOIL AT ANY ONE TIME WITHOUT PRIOR WRITTEN
  AUTHORIZATION FROM THE DEPARTMENT OR, IN AREAS UNDER THE JURISDICTION OF A REGULATED, TRADITIONAL LAND USE CONTROL MS4, THE REGULATED, TRADITIONAL LAND USE MS4. REFER TO THE REQUIREMENTS SET FORTH IN THE CURRENT GENERAL PERMIT FOR OBTAINING PERMISSION TO EXCEED THE FIVE (5) ACRE LIMIT.

#### B. PROJECT DESCRIPTION

THE PURPOSE OF THIS PROJECT IS TO CONSTRUCT A 68,240 SQUARE FOOT COMMERCIAL BUILDING, INCLUDING SEMI-TRAILER LOADING DOCKS AND PASSENGER

. CONSTRUCTION OF UNIT BLOCK RETAINING WALLS IS ALSO NECESSARY.

VEHICLE PARKING AREAS. 2. INSTALLATION OF NEW MUNICIPAL UTILITIES INCLUDING AN 8" WATER MAIN, SANITARY SEWER PIPING AND MANHOLES, PLUS STORM WATER COLLECTION SYSTEM PIPING AND

### C. SITE DESCRIPTION

- . THE SITE COVERS 4.4 ACRES OF VACANT LAND COVERED WITH VARIOUS TYPES OF WOODY VEGETATION, INCLUDING TREES, BRUSH AND WEEDS. THE SITE HAS BEEN USED FOR THE DISPOSAL OF SPOIL FROM OTHER PROPERTIES AND HAS AN IRREGULAR
- THE SITE IS. IN GENERAL LOWER THAN THE PROPERTIES TO THE EAST (INTERSTATE BATTERY) AND THE SOUTH (KONICA-MINOLTA), AND IS HIGHER THAN THE PROPERTY TO THE WEST (KING ZAK ENT.) AND POLICE DRIVE.
- STORMWATER DRAINAGE CONCENTRATES AT THE NORTHWESTERLY CORNER OF THE PROPERTY AND EXITS THROUGH AND EXISTING 30 INCH CMP CULVERT THAT CROSSES THE DRIVE OF KING ZAK ENTERPRISES AND TRAVELS TO AN EXISTING PONDING AREA CREATED BY THE OLD RAILROAD EMBANKMENT.
- i. The Principal soils in the area are erie gravelly silt loam, mardin gravelly SILT LOAM, AND BATH —NASSAU SHALY SILT LOAM. THE ERIE SOILS CONSIST OF DEEP, SOMEWHAT POORLY DRAINED, NEARLY LEVEL TO GENTLY SLOPING SOILS FORMED OVER DEEP BEDROCK IN GLACIAL TILL DEPOSITS AND UPLANDS. THE MARDIN SOILS CONSIST OF DEEP, MODERATELY WELL DRAINED, GENTLY SLOPING TO VERY STEEP SOILS, OVER DEEP BEDROCK IN GLACIAL TILL DEPOSITS IN UPLANDS. THE BATH—NASSAU SOIL HAS BETTER NATURAL DRAINAGE THAN THE ERIE AND MARDIN SOIL.

#### D. RESPONSIBILITY AND IMPLEMENTATION OF THE STORMWATER POLLUTION PREVENTION PLAN.

- THE OPERATOR IS THE **PERMITTEE** PURSUANT TO THE NEW YORK STATE SPDES PERMIT COVERING THE WORK. THE CONTRACTOR, AND HIS/HER SUBCONTRACTORS, IS OPERATOR OF ANY EROSION CONTROL PRACTICE INSTALLED IN ACCORDANCE WITH THE PLANS AND SPECIFICATIONS. OR AS DIRECTED.
- UPON COMPLETION OF THE WORK AND ACCEPTANCE OF THE STORMWATER POLLUTION PREVENTION SYSTEM CONSTRUCTED IN ACCORDANCE WITH THESE PLANS, THE CITY OF MIDDLETOWN WILL BE RESPONSIBLE FOR THE OPERATION AND MAINTENANCE OF SAID SYSTEM IN ACCORDANCE WITH THE CONDITIONS OF SAID

### E. CONSTRUCTION SEQUENCE

- INSTALL SILT FENCE, STRAW BALE DIKES AND OTHER EROSION CONTROL FEATURES AROUND PERIMETER OF AREAS TO BE DISTURBED, ANY STOCKPILE OF SOIL, AND WHERE NEEDED TO PREVENT THE MIGRATION OF SOIL DURING A RAIN EVENT.
- 2. INSTALL ROCK CONSTRUCTION SITE ENTRANCE AT POINT WHERE ACCESS TO THE WORK IS BEING OBTAINED FROM A TOWN ROAD OR HIGHWAY. (EG: POLICE DRIVE). 3. INSTALL PROPOSED SILTATION POND LOCATED ON THE NORTHWESTERLY PORTION OF THE PROJECT
- 4. PROVIDE SOLID WASTE CONTAINERS (eg: DUMPSTERS, TRASH BINS, GARBAGE CANS) FOR DISPOSAL OF ANCILLARY CONSTRUCTION DEBRIS, TRASH AND GARBAGE.
- . UPON COMPLETION OF EARTH MOVING ACTIVITIES, AND AFTER A PERMANENT VEGETATIVE COVER HAS BEEN ESTABLISHED ON EXPOSED EARTH SURFACES, AND THE RISK OF SOIL EROSION IS LOW, REMOVE SILT FENCE, STRAW BALE DIKES, STABILIZED CONSTRUCTION ENTRANCES AND/OR ANY OTHER TEMPORARY EROSION
- CLEAN ACCUMULATED SEDIMENT FROM SEDIMENT POND AND RESTORE AREA TO THE PRECONSTRUCTION SURFACE GRADES. STABILIZE AREA WITH SEED/MULCH AND/OR

### POLLUTION PREVENTION MEASURES

- THE CONTRACTOR SHALL PROVIDE DUST CONTROL, AS REQUIRED, ON A REGULAR BASIS TO ELIMINATE THE MIGRATION OF AIRBORNE SOIL PARTICLES. DUST CONTROL IS TO BE ACHIEVED BY SPRINKLING WITH WATER.
- THE CONTRACTOR SHALL PROVIDE LITTER CONTROL WITH THE USE OF COVERED TRASH RECEPTACLES, AND THE REGULAR CLEAN UP OF WASTE PAPER, WRAPPERS, CONTAINERS,
- 3. ALL OILS, GREASE, SOLVENTS AND OTHER FLUIDS NECESSARY FOR THE MAINTENANCE AND OPERATION OF EQUIPMENT USED FOR THE WORK ARE TO BE HANDLED PROPERLY, CONTAINED AND COLLECTED FOR USE OR DISPOSAL AT THE APPROPRIATE RECYCLING CENTER OR COLLECTION SITE.

PACKAGING AND SIMILAR TRASH GENERATED BY THE WORK AND WORKERS.

DEBRIS AND TRASH FROM CONSTRUCTION ACTIVITY SHALL BE COLLECTED BY THE CONTRACTOR ON A DAILY BASIS. THIS WASTE MATERIAL IS TO BE STORED IN CLOSED CONTAINERS AND ULTIMATELY REMOVED FROM THE SITE AND DISPOSED OF AT AN APPROVED DISPOSAL SITE. NO ON SITE BURIAL OF TRASH IS PERMITTED.

### CONSTRUCTION WASTE MATERIAL

- DEBRIS AND TRASH FROM CONSTRUCTION ACTIVITY SHALL BE COLLECTED BY THE CONTRACTOR ON A DAILY BASIS. THIS WASTE MATERIAL IS TO BE STORED IN CLOSED CONTAINERS (SEE E (5) ABOVE) AND ULTIMATELY REMOVED FROM THE SITE AND DISPOSED OF AT AN APPROVED DISPOSAL SITE.
- 1. NO ON-SITE BURIAL OF TRASH IS PERMITTED.

### H. STRUCTURAL AND VEGETATIVE MEASURES FOR SOIL STABILIZATION, RUNOFF CONTROL AND SEDIMENT CONTROL

1. TEMPORARY CONTROLS DURING CLEARING OPERATIONS, WOOD CHIPS FROM GROUND UP BRANCHES AND SMALL TREES MAY BE SPREAD OVER HAUL ROADS TO MINIMIZE SOIL EROSION. INSTALL SEDIMENT BARRIER (SILT) FENCE PRIOR TO ANY EXCAVATION WORK (INCLUDING STUMP REMOVAL) INSTALL STABILIZED ROCK CONSTRUCTION ENTRANCE PRIOR TO CONSTRUCTION TRAFFIC ENTERING AND LEAVING SITE. CONSTRUCT TEMPORARY DIVERSION SWALES AT ANY POINT WHERE SURFACE WATER CAN BE DIRECTED AWAY FROM DISTURBED SURFACES. IF A SURFACE WATER ROUTE CROSSES A DISTURBED AREA. PROVIDE A RIP-RAP CHANNEL AS SOON AS POSSIBLE AFTER THE CONSTRUCTION HAS PROGRESSED BEYOND THE WATER ROUTE PICK UP TRASH AND LIGHTWEIGHT RUBBISH THAT MAY BE SWEPT AWAY BY WIND. FILL OR GRADE VEHICLE TRACKS TO AVOID EROSION.

A) SEED AND MULCH EXPOSED EARTH AREAS TO ESTABLISH PERMANENT VEGETATIVE COVER AS SOON AS PRACTICAL AFTER FINAL GRADING. MULCH SHALL FOLLOW SEEDING BY NO MORE THAN 24 HOURS B) CONSTRUCT PERMANENT STORMWATER QUALITY POND AS SHOW ON THE ACCOMPANYING

- 3. TEMPORARY CONTROLS THAT ARE TO BE CONVERTED TO PERMANENT STORMWATER MANAGEMENT FACILITIES
- A) RIP-RAP OUTLET PROTECTION AND STONE LINED SWALES USED FOR SEDIMENT CONTROL SHALL BE RETAINED AS PERMANENT.
- 4. IMPLEMENTATION SCHEDULE OF EROSION AND SEDIMENT CONTROLS
- A) SEDIMENT BARRIER (SILT) FENCE SHALL BE INSTALLED PRIOR TO ANY SITE DISTURBANCE. B) STABILIZED ROCK CONSTRUCTION ENTRANCE SHALL BE INSTALLED PRIOR TO HEAVY TRUCK TRAFFIC ENTERING OR LEAVING THE SITE.
- C) TEMPORARY DIVERSION SWALES SHALL BE INSTALLED AS THE WORK PROCEEDS ACROSS THE PROJECT AREA D) STRAW BALE DIKES SHALL BE PLACED WHERE NEEDED IN CONJUNCTION WITH TEMPORARY SWALES AND WATER BARS. AS THE WORK PROCEEDS ACROSS THE PROJECT AREA.
- E) DUST CONTROL SHALL BE CONDUCTED DURING DRY WEATHER AS NEEDED OR DIRECTED. 5. MAINTENANCE SCHEDULE FOR EROSION AND SEDIMENT CONTROLS A) SEDIMENT BARRIER (SILT) FENCE: MAINTAIN PER DETAIL

B) STABILIZED ROCK CONSTRUCTION ENTRANCE SHALL BE MAINTAINED IN A CONDITION THAT

PREVENTS TRAFFIC FROM TRACKING SEDIMENT ONTO PUBLIC ROADWAYS. INSPECT AFTER

EACH RAIN AND PERIODICALLY REDRESS THE TOP AGGREGATE TO MAINTAIN EFFECTIVENESS. C) STRAW BALE DIKES REQUIRE FREQUENT INSPECTION AFTER EACH RAIN, AND SHALL BE

#### REMOVED AND REPLACED WHEN THEY HAVE SERVED THEIR USEFULNESS. D) TEMPORARY SWALES SHALL BE INSPECTED AFTER EACH RAIN. REPAIR ANY EROSION DAMAGE AND REMOVE ANY ACCUMULATION OF SEDIMENT IN SWALE OR IN OUTLET AREA

#### I. DRAINAGE CHARACTERISTICS AND CONTROL

TO RESTORE OPERATION.

WATER QUANTITY CONTROLS

RAINFALL EVENTS

A. POST CONSTRUCTION STORMWATER CONTROLS:

B. DRAINAGE REPORT (SEE SEPARATE DOCUMENTS):

LOCATION AND MANNER THAT IT WILL NOT ERODE.

DATED APRIL 2018, LATEST REVISION.

D. SITE ASSESSMENT AND INSPECTIONS:

FOLLOWING INFORMATION:

OR PERMANENT STABILIZATION:

DURING THE PREVIOUS 14-DAY PERIOD:

(SEDIMENT BASINS AND SEDIMENT TRAPS).

BARRIER OR DIVERSION SYSTEMS.

ACTIVITIES ON A MONTHLY BASIS.

(FOR EXAMPLE, 10 PERCENT, 20 PERCENT, 50 PERCENT);

ANY LOSS OF STABILIZING VEGETATION OR SEEDING/MULCHING.

AROUND PERFORATED RISER PIPES TO PASS WATER;

WATER CONTROL PRACTICES:

- 1. THE WORK AREA IS TRIBUTARY TO AN EXISTING 30 INCH CMP CULVERT PASSING UNDER THE DRIVE TO KING ZAK ENTERPRISES. THERE ARE TWO SEPARATE INLETS TO THIS CULVERT.
- 2. THERE IS A DRAINAGE SWALE THAT PARALLELS POLICE DRIVE THAT RECEIVES RUNOFF FROM AN EXISTING DRAINAGE PIPE UNDER THE DRIVE FOR INTERSTATE BATTERY. SUBSTANTIAL FLOWS CAN BE EXPECTED IN THIS SWALE DURING A RAIN EVENT, AND WILL NEED TO BE ACCOMODATED DURING AND AFTER CONSTRUCTION.
- SURFACE RUNOFF WATER THAT IS RELATIVELY CLEAN AND SEDIMENT FREE AND SHALL BE DIVERTED FROM THE WORK WHENEVER POSSIBLE.
- 4. ALTHOUGH NONE OF THESE WATER COURSES ARE PROTECTED STREAMS, THEY ARE

II FOR CONSTRUCTION ACTIVITIES WITH WATER QUALITY &

POST CONSTRUCTION STORMWATER CONTROLS ARE LIMITED TO THE WATER QUALITY

THE PROPOSED DEVELOPMENT. THESE PONDS WILL FILL WITH WATER DURING HEAVY

1) "STORMWATER RUNOFF ANALYSIS PREPARED FOR 1 POLICE DRIVE AND 3 POLICE

1. STORMWATER CONTROL DEVICES INCLUDING CATCH BASINS AND PONDS SHALL BE

DRIVE, GOSHEN, NY" PERPARED BY T.M. DEPUY ENGINEERING AND LAND SURVEYING,

INSPECTED AND CLEANED WHEN SEDIMENT ACCUMULATIONS REACH 1/2 THE DESIGN DEPTH OF THE STRUCTURE. REMOVED SEDIMENT SHALL BE DEPOSITED IN SUCH A

2. BIO-RETENTION AREA SHALL BE INSPECTED AFTER EACH STORM EVENT FOR DAMAGE

FROM EROSION, REMOVE ANY ACCUMULATED DEBRIS AND DETERMINE IF SEDIMENT

NEEDS TO BE REMOVED. ON A MONTHLY BASIS, INSPECT FILTER TO DETERMINE

3. CHECK BIO-RETENTION AREA FOR PROPER PLANT GROWTH (NO INAPPROPRIATE

1. THE OPERATOR SHALL HAVE A QUALIFIED PROFESSIONAL CONDUCT AN ASSESSMENT OF

DESCRIBED IN (\*). THE SWPPP OF THIS PERMIT HAVE BEEN ADEQUATELY INSTALLED OR

SHALL BE CONDUCTED BY THE QUALIFIED PROFESSIONAL AT LEAST EVERY 7 CALENDAR

GREATER. DURING EACH INSPECTION, THE QUALIFIED PROFESSIONAL SHALL RECORD THE

a) ON A SITE MAP, INDICATE THE EXTENT OF ALL DISTURBED SITE AREAS AND DRAINAGE

b) INDICATE ON A SITE MAP ALL AREAS OF THE SITE THAT HAVE UNDERGONE TEMPORARY

c) INDICATE ALL DISTURBED SITE AREAS THAT HAVE NOT UNDERGONE ACTIVE SITE WORK

d) INSPECT ALL SEDIMENT CONTROL PRACTICES AND RECORD THE APPROXIMATE DEGREE

OF SEDIMENT ACCUMULATION AS A PERCENTAGE OF THE SEDIMENT STORAGE VOLUME

DIVERSION SYSTEMS (EARTHEN BERMS OR SILT FENCING) AND CONTAINMENT SYSTEMS

DAYS AND WITHIN 24 HOURS OF THE END OF A STORM EVENT OF 0.5 INCHES OR

PATHWAYS. INDICATE SITE AREAS THAT ARE EXPECTED TO UNDERGO INITIAL

DISTURBANCE OR SIGNIFICANT SITE WORK WITHIN THE NEXT 14-DAY PERIOD;

e) INSPECT ALL EROSION AND SEDIMENT CONTROL PRACTICES AND RECORD ALL

HAS BEEN REDUCED BY FIFTY (50) PERCENT FROM THE DESIGN CAPACITY.

MAINTENANCE REQUIREMENTS SUCH AS VERIFYING THE INTEGRITY OF BARRIER OR

f) IDENTIFY ANY EVIDENCE OR RILL OR GULLY EROSION OCCURRING ON SLOPES AND

g) DOCUMENT ANY EXCESSIVE DEPOSITION OF SEDIMENT OR PONDING WATER ALONG

h) RECORD THE DEPTH OF SEDIMENT WITHIN CONTAINMENT STRUCTURES, ANY EROSION

i) ALL DEFICIENCIES THAT ARE IDENTIFIED WITH THE IMPLEMENTATION OF THE SWPPP.

2. THE OPERATOR SHALL MAINTAIN A RECORD OF ALL INSPECTION REPORTS IN A SITE LOG

THE PERMITTING AUTHORITY UPON REQUEST. PRIOR TO THE COMMENCEMENT OF

CONSTRUCTION (1) THE OPERATOR SHALL CERTIFY IN THE SITE LOG BOOK THAT THE

BOOK. THE SITE LO BOOK SHALL BE MAINTAINED ON SITE AND BE MADE AVAILABLE TO

SWPPP, PREPARED IN ACCORDANCE WITH THIS PERMIT, MEETS ALL FEDERAL, STATE AND

AT THE SITE, IN A PUBLICLY-ACCESSIBLE LOCATION, A SUMMARY OF THE SITE INSPECTION

LOCAL EROSION AND SEDIMENT CONTROL REQUIREMENTS. THE OPERATOR SHALL POST,

NEAR OUTLET AND OVERFLOW STRUCTURES, AND VERIFY THE ABILITY OF ROCK FILTERS

IMPLEMENTED TO INSURE OVERALL PREPAREDNESS OF THE SITE FOR THE COMMENCEMENT

OF CONSTRUCTION. FOLLOWING THE COMMENCEMENT OF CONSTRUCTION, SITE INSPECTIONS

THE SITE PRIOR TO THE COMMENCEMENT OF CONSTRUCTION AND CERTIFY IN AN

INSPECTION REPORT THAT THE APPROPRIATE EROSION AND SEDIMENT CONTROLS

THE LOCATION AND DETAIL OF THE STORMWATER CONTROL PRACTICES REQUIRED.

REFER TO SEPARATE REPORTS HEREBY MADE PART OF THIS SWPP PLAN:

C. MAINTENANCE SCHEDULE FOR POST-CONSTRUCTION STORM

WHETHER RETENTION BASIN DRAINS PROPERLY BETWEEN STORMS.

PONDS INDICATED ON THE PLANS, AND ARE INTENDED TO PROVIDE THE REQUIRED WATER QUALITY VOLUME NECESSARY FOR THE PROPOSED DEVELOPMENT. THE AREA ABOVE THE

PONDS NORMAL WATER LEVEL IS ESSENTIAL IN MITIGATING THE INCREASED RUNOFF FROM

#### 3. PRIOR TO FILING OF THE NOTICE OF TERMINATION (NOT) OR THE END OF PERMIT TERM, THE OPERATOR SHALL HAVE THE QUALIFIED PROFESSIONAL PERFORM A FINAL SITE INSPECTION. THE QUALIFIED PROFESSIONAL SHALL CERTIFY THAT THE SITE HAS UNDERGONE FINAL STABILIZATION (2) USING EITHER VEGETATIVE OR STRUCTURAL STABILIZATION METHODS AND THAT ALL TEMPORARY EROSION AND SEDIMENT CONTROLS EROSION CONTROL HAVE BEEN REMOVED (SUCH AS STILT FENCING) NOT NEEDED FOR LONG-TERM VED.

4. THE OPERATOR SHALL CERTIFY THAT THE REQUIREMENTS OF THIS PERMIT HAVE BEEN SATISFIED WITHIN 48 HOURS OF ACTUALLY MEETING SUCH REQUIREMENTS.

#### STABILIZATION<sup>(3)</sup>

- THE OPERATOR SHALL INITIATE STABILIZATION MEASURES AS SOON AS PRACTICABLE IN PORTIONS OF THE SITE WHERE SOIL DISTURBANCE ACTIVITIES HAVE TEMPORARILY OR PERMANENTLY CEASED, BUT IN NO CASE MORE THAN 7 DAYS AFTER THE SOIL DISTURBANCE ACTIVITY IN THAT PORTION OF THE SITE HAS TEMPORARILY OR
- 2. TEMPORARY STABILIZATION MEANS THAT EXPOSED SOIL HAS BEEN COVERED WITH MATERIAL(S) SET FORTH IN THE TECHNICAL STANDARD, TO PREVENT SOIL FROM
- 3. FINAL STABILIZATION MEANS THAT ALL SOIL DISTURBANCE ACTIVITIES HAVE CEASED AND A UNIFORM PERENNIAL VEGETATIVE COVER WITH A STEM DENSITY OF EIGHTY (80) PERCENT OVER THE ENTIRE PERVIOUS SURFACE HAS BEEN ESTABLISHED, OR OTHER FOUVALENT STABILIZATION MEASURES. SUCH AS PERMANENT LANDSCAPE MULCHES. ROCK RIP-RAP OR WASHED/CRUSHED STONE HAVE BEEN APPLIED ON ALL DISTURBED AREAS THAT ARE NOT COVERED BY PERMANENT STRUCTURES, CONCRETE OR PAVEMENT.

### F. MAINTENANCE

SEDIMENT SHALL BE REMOVED FROM SEDIMENT TRAPS OR SEDIMENT PONDS WHENEVER THEIR CAPACITY HAS BEEN REDUCED BY FIFTY (50) PERCENT FROM THE

### REPORTING & RETENTION OF RECORDS (PERMIT PART VI)

#### A. RECORD RETENTION

THE OWNER OR OPERATOR SHALL RETAIN A COPY OF THE NOI, NOI ACKNOWLEDGMENT LETTER, SWPPP, MS4 SWPPP ACCEPTANCE FORM AND ANY INSPECTION REPORTS THAT WERE PREPARED IN CONJUNCTION WITH THIS PERMIT FOR A PERIOD OF AT LEAST FIVE (5) YEARS FROM THE DATE THAT THE DEPARTMENT RECEIVES A COMPLETE NOT SÙÉMITTED IN ACCORDANCE WITH PART V. OF THIS GENERAL PERMIT.

#### B. ADDRESSES

WITH THE EXCEPTION OF THE NOI, NOT, AND MS4 SWPPP ACCEPTANCE FORM (WHICH MUST BE SUBMITTED TO THE ADDRESS REFERENCED IN PART II.A.1), ALL WRITTEN CORRESPONDENCE REQUESTED BY THE DEPARTMENT, INCLUDING INDIVIDUAL PERMIT APPLICATIONS, SHALL BE SENT TO THE ADDRESS OF THE APPROPRIATE DOW WATER (SPDES) PROGRAM CONTACT AT THE REGINAL OFFICE LISTED IN APPENDIX F.

#### NYS DEPT. OF ENVIRONMENTAL CONSERVATION DIVISION OF FNVIRONMENTAL PERMITS 21 SOUTH PUTTS CORNERS ROAD

#### NEW PALTZ, NY 12561-1696 STANDARD PERMIT CONDITIONS (PERMIT PART VII)

### A. DUTY TO COMPLY:

THE OWNER OR OPERATOR MUST COMPLY WITH ALL CONDITIONS OF THIS PERMIT. ALL CONTRACTORS AND SUBCONTRACTORS ASSOCIATED WITH THE PROJECT MUST COMPLY WITH THE TERMS OF THE SWPPP. ANY NON-COMPLIANCE WITH THIS PERMIT CONSTITUTES A VIOLATION OF THE CLEAN WATER ACT (CWA) AND THE ECL, AND IS GROUNDS FOR AN ENFORCEMENT ACTION AGAINST THE OWNER OR OPERATOR AND/OR THE CONTRACTOR/SUBCONTRACTOR; PERMIT REVOCATION OR MODIFICATION; OR DENIAL OF A PERMIT RENEWAL APPLICATION. UPON A FINDING OF SIGNIFICANT NON—COMPLIANCE WITH THIS PERMIT OR THE APPLICABLE SWPPP, THE DEPARTMENT MAY ORDER AN IMMEDIATE STOP TO ALL CONSTRUCTION ACTIVITY AT THE SITE UNTIL THE NON—COMPLIANCE IS REMEDIED. THE STOP WORK ORDER SHALL BE IN WRITING, SHALL DESCRIBE THE NON— COMPLIANCE IN DETAIL, AND SHALL BE SENT TO THE OWNER OR OPERATOR.

IF ANY HUMAN REMAINS OR ARCHAEOLOGICAL REMAINS ARE ENCOUNTERED DURING ESCAVATION, THE OWNER OR OPERATOR MUST IMMEDIATELY CEASE, OR CAUSE TO CEASE, ALL CONSTRUCTION ACTIVITY IN THE AREA OF THE REMAINS AND NOTIFY THE REGIONAL WATER ENGINEER (RWE). CONSTRUCTION ACTIVITY SHALL NOT RESUME UNTIL WRITTEN PERMISSION TO DO SO HAS BEEN RECEIVED FROM THE RWE.

### REFER TO THE SOIL EROSION AND SEDIMENTATION CONTROL DRAWINGS AND DETAILS FOR B. CONTINUATION OF THE EXPIRED GENERAL PERMIT:

THIS PERMIT EXPIRES FIVE (5) YEARS FROM EFFECTIVE DATE. IF THE NEW GENERAL PERMIT IS NOT ISSUED PRIOR TO THE EXPIRATION OF THIS GENERAL PERMIT, AND OWNER OR OPERATOR WITH COVERAGE UNDER THIS PERMIT MAY CONTINUE TO OPERATE AND DISCHARGE IN ACCORDANCE WITH THE TERMS AND CONDITIONS OF THIS GENERAL PERMIT, IF IT IS EXTENDED PURSUANT TO THE STATE ADMINISTRATIVE PROCEDURE ACT AND 6 NYCRR PART 621, UNTIL A NEW GENERAL PERMIT IS ISSUED.

FAILURE OR THE OWNER OR OPERATOR, ITS CONTRACTORS, SUBCONTRACTORS, AGENTS AND/OR ASSIGNS TO STRICTLY ADHERE TO ANY OF THE PERMIT REQUIREMENTS CONTAINED HEREIN SHALL CONSTITUTE A VIOLATION OF THIS THERE ARE SUBSTANTIAL CRIMINAL, CIVIL, AND ADMINISTRATIVE PENALTIES ASSOCIATED WITH VIOLATING THE PROVISIONS OF THIS PERMIT. FINES OF UP TO \$37,500 PER DAY FOR EACH VIOLATION AND IMPRISONMENT FOR UP TO FIFTEEN (15) YEARS MAY BE ASSESSED DEPENDING UPON THE NATURE AND DEGREE OF

### NEED TO HALT OR REDUCE ACTIVITY NOT A DEFENCE:

IT SHALL NOT BE A DEFENSE FOR AN OWNER OR OPERATOR IN AN ENFORCEMENT ACTION THAT IT WOULD HAVE BEEN NECESSARY TO HALT OR REDUCE THE CONSTRUCTION ACTIVITY IN ORDER TO MAINTAIN COMPLIANCE WITH THE CONDITIONS

### E. DUTY TO MITIGATE:

THÉ OFFENCE.

- THE OWNER OR OPERATOR AND ITS CONTRACTORS AND SUBCONTRACTORS SHALL TAKE ALL REASONABLE STEPS TO MINIMIZE OR PREVENT ANY DISCHARGE IN VIOLATION OF THIS PERMIT WHICH HAS A REASONABLE LIKELIHOOD OF ADVERSELY AFFECTING HUMAN HEALTH OR THE ENVIRONMENT. F. DUTY TO PROVIDE INFORMATION
- H. THE OWNER OR OPERATOR SHALL FURNISH THE DEPARTMENT, WITHIN A REASONABLE SPECIFIED TIME PERIOD OF A WRITTEN REQUEST, ALL DOCUMENTATION NECESSARY TO DEMONSTRATE ELIGIBILITY AND ANY INFORMATION T DETERMINE COMPLIANCE WITH THIS PERMIT. OR TO DETERMINE WHETHER CAUSE EXISTS FOR MODIFYING OR REVOKING THIS PERMIT, OR SUSPENDING OR DENYING COVERAGE UNDER THIS PERMIT, IN ACCORDANCE WITH THE TERMS AND CONDITIONS OF THIS PERMIT. THE NOI, SWPPP AND INSPECTION REPORTS REQUIRED BY THIS PERMIT ARE PUBLIC DOCUMENTS THAT THE OWNER OR OPERATOR MUST MAKE AVAILABLE FOR REVIEW AND COPYING BY ANY PERSON WITHIN FIVE (5) BUSINESS DAYS OF THE OWNER OR OPERATOR RECEIVING A WRITTEN REQUEST BY ANY SUCH PERSON TO REVIEW THESE DOCUMENTS. COPYING OF DOCUMENTS WILL BE DONE AT THE REQUESTER'S EXPENSE.
- G. OTHER INFORMATION WHEN THE OWNER OR OPERATOR BECOMES AWARE THAT THEY FAILED TO SUBMIT ANY RELEVANT FACTS, OR SUBMITTED INCORRECT INFORMATION IN THE NOI OR IN ANY OF THE DOCUMENTS REQUIRED BY THIS PERMIT, OR HAVE MADE SUBSTANTIVE REVISIONS TO THE SWPPP (e.g. THE SCOPE OF THE PROJECT CHANGES SIGNIFICANTLY, THE POST-CONSTRUCTION STORMWATER MANAGEMENT PRACTICE(S) CHANGE. THERE IS A REDUCTION IN THE SIZING OF THE POST-CONSTRUCTION STORMWATER MANAGEMENT PRACTICE. OR THERE IS AN INCREASE IN THE DISTURBANCE AREA OR IMPERVIOUS AREA) WHICH WERE NOT REFLECTED IN THE ORIGINAL NOI SUBMITTED TO THE DEPARTMENT, THEY SHALL PROMPTLY SUBMIT SUCH FACTS OR INFORMATION TO THE DEPARTMENT USING THE CONTACT INFORMATION IN PART II.A. OF THIS PERMIT. FAILURE OF THE OWNER OR

OPERATOR TO CORRECT OR SUPPLEMENT ANY RELEVANT FACTS WITHIN FIVE (5

BUSINESS DAYS OF BECOMING AWARE OF THE DEFICIENCY SHALL CONSTITUTE  $ar{\prime}$ 

#### VIOLATION OF THIS PERMIT. SIGNATORY REQUIREMENTS:

- 1. ALL NOIS AND NOTS SHALL BE SIGNED AS FOLLOWS:
  - FOR A CORPORATION THESE FORMS SHALL BE SIGNED BY A RESPONSIBLE CORPORATE OFFICER. FOR THE PURPOSE OF THIS SECTION, A RESPONSIBLE CORPORATE OFFICER MEANS:
  - I. A PRESIDENT, SECRETARY, TREASURER, OR VICE-PRESIDENT OF THE CORPORATION IN CHARGE OF A PRINCIPAL BUSINESS FUNCTION, OR ANY OTHER PERSON WHO PERFORMS SIMILAR POLICY OR DECISION-MAKING FUNCTIONS FOR THE CORPORATION; OR
  - II. THE MANAGER OF ONE OR MORE MANUFACTURING, PRODUCTION OR OPERATING FACILITIES, PROVIDED THE MANAGER IS AUTHORIZED T MAKE MANAGEMENT DECISIONS WHICH GOVERN THE OPERATION OF THE REGULATED FACILITY INCLUDING HAVING THE EXPLICIT OR IMPLICIT DUTY OF MAKING MAJOR CAPITAL INVESTMENT RECOMMENDATIONS, AND INITIATING AND DIRECTING OTHER COMPREHENSIVE MEASURES TO ASSURE LONG TERM ENVIRONMENTAL COMPLIANCE WITH ENVIRONMENTAL LAWS AND REGULATIONS; THE MANAGER CAN ENSURE THAT THE NECESSARY SYSTEMS ARE ESTABLISHED OR ACTIONS TAKEN TO GATHER COMPLETE AND ACCURATE INFORMATION FOR PERMIT APPLICATION REQUIREMENTS; AND WHERE AUTHORITY TO SIGN DOCUMENTS HAS BEEN ASSIGNED OR DELEGATED TO THE MANAGER IN ACCORDANCE WITH CORPORATE PROCEDURES:

- B. FOR A PARTNERSHIP OR SOLE PROPRIETORSHIP THESE FORMS SHALL BE SIGNED BY A GENERAL PARTNER OR THE PROPRIETOR, RESPECTIVELY; OR
- C. FOR A MUNICIPALITY, STATE, FEDERAL, OR OTHER PUBLIC AGENCY THESE FORMS SHALL BE SIGNED BY EITHER A PRINCIPAL EXECUTIVE OFFICER OR RANKING ELECTED OFFICIAL. FOR PURPOSES OF THIS SECTION, A PRINCIPAL EXECUTIVE OFFICER OF A FEDERAL AGENCY INCLUDES:
- I. THE CHIEF EXECUTIVE OFFICER OF THE AGENCY, OR
- II. A SENIOR EXECUTIVE OFFICER HAVING RESPONSIBILITY FOR THE OPERATIONS OF A PRINCIPAL GEOGRAPHIC UNIT OF THE AGENCY (E.G., REGIONAL ADMINISTRATORS OF EPA).
- THE SWPPP AND OTHER INFORMATION REQUESTED BY THE DEPARTMENT SHALL BE SIGNED BY A PERSON DESCRIBED IN PART VII.H.1. OR BY A DULY AUTHORIZED REPRESENTATIVE OF THAT PERSON. A PERSON IS A DULY AUTHORIZED REPRESENTATIVE ONLY IF:
- A. THE AUTHORIZATION IS MADE IN WRITING BY A PERSON DESCRIBED IN PART
- VII.H.1 OF THIS PERMIT; B. THE AUTHORIZATION SPECIFIES EITHER AN INDIVIDUAL OR A POSITION HAVING RESPONSIBILITY FOR THE OVERALL OPERATION OF THE REGULATED FACILITY OR ACTIVITY, SUCH AS THE POSITION OF PLANT MANAGER, OPERATOR OF A WELL OR A WELL FIELD, SUPERINTENDENT, POSITION OF EQUIVALENT RESPONSIBILITY, OR AN INDIVIDUAL OR POSITION HAVING OVERALL RESPONSIBILITY FOR ENVIRONMENTAL MATTERS FOR THE COMPANY. (A DULY AUTHORIZED REPRESENTATIVE MAY THUS BE EITHER A
- C. THE WRITTEN AUTHORIZATION SHALL INCLUDE THE NAME, TITLE AND SIGNATURE OF THE AUTHORIZED REPRESENTATIVE AND BE ATTACHED TO

NAMED INDIVIDUAL OR ANY INDIVIDUAL OCCUPYING A NAMED POSITION) AND,

- 3. ALL INSPECTION REPORTS SHALL BE SIGNED BY THE QUALIFIED INSPECTOR THAT PERFORMS THE INSPECTION.
- THE MS4 SWPPP ACCEPTANCE FORM SHALL BE SIGNED BY THE PRINCIPAL EXECUTIVE OFFICER OR RANKING ELECTED OFFICIAL FROM THE REGULATED, TRADITIONAL LAND USE CONTROL MS4, OR BY A DULY AUTHORIZED REPRESENTATIVE OF THAT PERSON. IT SHALL CONSTITUTE A PERMIT VIOLATION IF AN INCORRECT AND/OR IMPROPER
- SIGNATORY AUTHORIZES ANY REQUIRED FORMS, SWPPP AND/OR INSPECTION I. PROPERTY RIGHTS

THE ISSUANCE OF THIS PERMIT DOES NOT CONVEY ANY PROPERTY RIGHTS OF ANY SORT, NOR ANY EXCLUSIVE PRIVILEGES, NOR DOES IT AUTHORIZE ANY INJURY TO PRIVATE PROPERTY NOR ANY INVASION OF PERSONAL RIGHTS, NOR ANY INFRINGEMENT OF FEDERAL, STATE OR LOCAL LAWS OR REGULATIONS. OWNERS OR OPERATORS MUST OBTAIN ANY APPLICABLE CONVEYANCES. EASEMENTS. LICENSES AND/OR ACCESS TO REAL PROPERTY PRIOR TO COMMENCING CONSTRUCTION ACTIVITY.

#### J. SEVERABILITY

THE PROVISIONS OF THIS PERMIT ARE SEVERABLE, AND IF ANY PROVISION OF THIS PERMIT, OR THE APPLICATION OF ANY PROVISION OF THIS PERMIT TO ANY CIRCUMSTANCE, IS HELD INVALID. THE APPLICATION OF SUCH PROVISION TO OTHER CIRCUMSTANCES, AND THE REMAINDER OF THIS PERMIT SHALL NOT BE AFFECTED

### K. REQUIREMENT TO OBTAIN COVERAGE UNDER AN ALTERATIVE PERMIT

- 1. THE DEPARTMENT MAY REQUIRE ANY OWNER OR OPERATOR AUTHORIZED BY THIS PERMIT TO APPLY FOR AND/OR OBTAIN EITHER AN INDIVIDUAL SPDES PERMIT OR ANOTHER SPDES GENERAL PERMIT. WHEN THE DEPARTMENT REQUIRES ANY DISCHARGER AUTHORIZED BY A GENERAL PERMIT TO APPLY FOR AN INDIVIDUAL SPDES PERMIT. IT SHALL NOTIFY THE DISCHARGER IN WRITING THAT A PERMIT APPLICATION IS REQUIRED. THIS NOTICE SHALL INCLUDE A BRIEF STATEMENT OF THE REASONS FOR THIS DECISION, AN APPLICATION FORM, A STATEMENT SETTING A TIME FRAME FOR THE OWNER OR OPERATOR TO FILE THE APPLICATION FOR AN INDIVIDUAL SPDES PERMIT, AND A DEADLINE, NOT SOONER THAN 180 DAYS FROM OWNER OR OPERATOR RECEIPT OF THE NOTIFICATION LETTER. WHEREBY THE AUTHORIZATION TO DISCHARGE UNDER THIS GENERAL PERMIT SHALL BE TERMINATED. APPLICATIONS MUST BE SUBMITTED TO THE APPROPRIATE PERMIT ADMINISTRATOR AT THE REGIONAL OFFICE. THE DEPARTMENT MAY GRANT ADDITIONAL TIME UPON DEMONSTRATION, TO THE SATISFACTION OF THE DEPARTMENT, THAT ADDITIONAL TIME TO APPLY FOR AN AITERNATIVE AUTHORIZATION IS DEPARTMENT HAS NOT PROVIDED A PERMIT DETERMINATION IN ACCORDANCE WITH PART 621 OF THIS TITLE.
- 2. WHEN AN INDIVIDUAL SPDES PERMIT IS ISSUED TO A DISCHARGER AUTHORIZED TO DISCHARGE UNDER A GENERAL SPDES PERMIT FOR THE SAME DISCHARGE(S), THE GENERAL PERMIT AUTHORIZATION FOR OUTFALLS AUTHORIZED UNDER THE INDIVIDUAL SPDES PERMIT IS AUTOMATICALLY TERMINATED ON THE EFFECTIVE DATE OF THE INDIVIDUAL PERMIT UNLESS TERMINATION IS EARLIER IN ACCORDANCE WITH 6 NYCRR PART 750.

### L. PROPER OPERATION AND MAINTENANCE

THE OWNER OR OPERATOR SHALL AT ALL TIMES PROPERLY OPERATE AND MAINTAIN ALL FACILITIES AND SYSTEMS OF TREATMENT AND CONTROL (AND RELATED APPURTENANCES) WHICH ARE INSTALLED OR USED BY THE OWNER OR OPERATOR TO ACHIEVE COMPLIANCE WITH THE CONDITIONS OF THIS PERMIT AND WITH THE REQUIREMENTS OF THE SWPPP.

### M. INSPECTION AND ENTRY

THE OWNER OR OPERATOR SHALL ALLOW AN AUTHORIZED REPRESENTATIVE OF THE DEPARTMENT, EPA, APPLICABLE COUNTY HEALTH DEPARTMENT, OR, IN THE CASE OF A CONSTRUCTION SITE WHICH DISCHARGES THROUGH AN MS4, AN AUTHORIZED REPRESENTATIVE OF THE MS4 RECEIVING THE DISCHARGE, UPON THE PRESENTATION OF CREDENTIALS AND OTHER DOCUMENTS AS MAY BE REQUIRED BY LAW, TO:

- ENTER UPON THE OWNER'S OR OPERATOR'S PREMISES WHERE A REGULATED FACILITY OR ACTIVITY IS LOCATED OR CONDUCTED OR WHERE RECORDS MUST BE KEPT UNDER THE CONDITIONS OF THIS
- 2. HAVE ACCESS TO AND COPY AT REASONABLE TIMES, ANY RECORDS THAT MUST BE KEPT UNDER THE CONDITIONS OF THIS PERMIT; AND
- 3. INSPECT AT REASONABLE TIMES ANY FACILITIES OR EQUIPMENT (INCLUDING MONITORING AND CONTROL EQUIPMENT).
- 4. SAMPLE OR MONITOR AT REASONABLE TIMES, FOR PURPOSES OF ASSURING PERMIT COMPLIANCE OR AS OTHERWISE AUTHORIZED BY THE ACT OR ECL, ANY SUBSTANCES OR PARAMETERS AT ANY LOCATION.

### N. PERMIT ACTIONS

THIS PERMIT MAY, AT ANY TIME, BE MODIFIED, SUSPENDED, REVOKED, OR RENEWED BY THE DEPARTMENT IN ACCORDANCE WITH 6 NYCRR PART 621. THE FILING OF A REQUEST BY THE OWNER OR OPERATOR FOR A PERMIT MODIFICATION, REVOCATION AND REISSUANCE, TERMINATION, A NOTIFICATION OF PLANNED CHANGES OR ANTICIPATED NONCOMPLIANCE DOES NOT LIMIT, DIMINISH AND/OR STAY COMPLIANCE WITH ANY TERMS OF THIS PERMIT.

### O. DEFINITIONS

DEFINITIONS OF KEY TERMS ARE INCLUDED IN APPENDIX A (NOT INCLUDED HEREON) OF THIS PERMIT.

### P. RE-OPENER CLAUSE

- 1. IF THERE IS EVIDENCE INDICATING POTENTIAL OR REALIZED IMPACTS ON WATER QUALITY DUE TO ANY STORMWATER DISCHARGE ASSOCIATED WITH CONSTRUCTION ACTIVITY COVERED BY THIS PERMIT, THE OWNER OR OPERATOR OF SUCH DISCHARGE MAY BE REQUIRED TO OBTAIN AN INDIVIDUAL PERMIT OR ALTERNATIVE GENERAL PERMIT IN ACCORDANCE WITH PART VII.K. OF THIS PERMIT OR THE PERMIT MAY BE MODIFIED TO INCLUDE DIFFERENT LIMITATIONS AND/OR REQUIREMENTS.
- 2. ANY DEPARTMENT INITIATED PERMIT MODIFICATION, SUSPENSION OR REVOCATION WILL BE CONDUCTED IN ACCORDANCE WITH 6 NYCRR PART 621, 6 NYCRR 750-1.18, AND 6 NYCRR 750-1.20.

### Q. PENALTIES FOR FALSIFICATION OF FORMS AND REPORTS

IN ACCORDANCE WITH 6 NYCRR OART 750-2.4 AND 750-2.5. ANY PERSON WHO KNOWINGLY MAKES ANY FALSE MATERIAL STATEMENT. REPERSENTATION, OR CERTIFICATION IN ANY APPLICATION, RECORD, REPORT OR OTHER DOCUMENT FILED OR REQUIRED TO BE MAINTAINED UNDER THIS PERMIT. INCLUDING REPORTS OF COMPLIANCE OR NON-COMPLIANCE SHALL, UPON CONVICTION, BE PUNISHED IN ACCORDANCE WITH ECL \$ 71-1933 AND OR ARTICLES 175 AND 210 OF THE NEW YORK STATE PENAL LAW.

NOTHING IN THIS PERMIT RELIEVES THE OWNER OR OPERATOR FROM A REQUIREMENT TO OBTAIN ANY OTHER PERMITS REQUIRED BY LAW.

# OWNER/OPERATORS CERTIFICATION (SEE PART 1.D "RESPONSIBILITY") "I CERTIFY UNDER PENALTY OF LAW THAT THIS DOCUMENT AND ALL ATTACHMENTS WERE PREPARED UNDER MY DIRECT SUPERVISION IN ACCORDANCE WITH THE SYSTEM DESIGNED TO ASSURE THAT QUALIFIEDPERSONNEL PROPERLY GATHERED AND EVALUATED THE INFORMATION SUBMITTED. BASED ON MY INQUIRY OF THE PERSON OR PERSONS WHO MANAGE THE SYSTEM, OR THOSE PERSONS DIRECTLY RESPONSIBLE FOR GATHERING THE INFORMATION, THE INFORMATION SUBMITTED IS, TO THE BEST OF MY KNOWLEDGE AND BELIEF, TRUE, ACCURATE, AND COMPLETE. FURTHER, I HEREBY CERTIFY THAT THE SWPPP MEETS ALL FEDERAL, STATE, AND LOCAL EROSION AND SEDIMENT CONTROL REQUIREMENTS. I AM AWARE THAT FALSE STATEMENTS HEREON ARE PUNISHABLE AS A CLASS A MISDEMEANOR PURSUANT TO SECTION 210.45 OF THE PENAL LAW" ADDRESS -

OWNER/OPERATORS	CERTIFICATION	(SEE PART 1.D "RESPONSIBILITY" )
PREPARED UNDER MY DIRECT SUPE THAT QUALIFIEDPERSONNEL PROPER BASED ON MY INQUIRY OF THE PER DIRECTLY RESPONSIBLE FOR GATHE BEST OF MY KNOWLEDGE AND BELI THAT THE SWPPP MEETS ALL FEDE	TRVISION IN ACCORDANCE WITERLY GATHERED AND EVALUAT RSON OR PERSONS WHO MAN RING THE INFORMATION, THE EF, TRUE, ACCURATE, AND C RAL, STATE, AND LOCAL ERC AT FALSE STATEMENTS HERI	NAGE THE SYSTEM, OR THOSE PERSONS INFORMATION SUBMITTED IS, TO THE COMPLETE. FURTHER, I HEREBY CERTIFY DISION AND SEDIMENT CONTROL EON ARE PUNISHABLE AS A CLASS A
NAME (PRINT) —		
ПТLE		DATE
ADDRESS —		
TEPLEPHONE —		— EMAIL ————
SIGNATU	RE	


#### FOOTNOTES:

- (1) "COMMENCEMENT OF CONSTRUCTION" MEANS THE INITIAL REMOVAL OF VEGETATION AND DISTURBANCE OF SOILS ASSOCIATED WITH CLEARING, GRADING OR EXCAVATING ACTIVITIES OR OTHER CONSTRUCTION ACTIVITIES.
- (2) "FINAL STABILIZATION" MEANS THAT ALL SOIL DISTURBING ACTIVITIES AT THE SITE HAVE BEEN COMPLETED AND A UNIFORM, PERENNIAL VEGETATIVE COVER WITH A DENSITY OF EIGHTY (80) PERCENT HAS BEEN ESTABLISHED OR EQUIVALENT STABILIZATION MEASURES SUCH AS THE USE OF MULCHES OR GEOTEXTILES) HAVE BEEN EMPLOYED ON ALL UNPAVED AREAS AND AREAS NOT COVERED BY PERMANENT STRUCTURES.
- (3) "STABILIZATION" MEANS COVERING OR MAINTAINING AN EXISTING COVER OVER SOIL. COVER CAN BE VEGETATIVE (E.G. GRASS, TREES, SEED AND MULCH, SHRUBS, OR TURF) OR NON-VEGETATIVE (E.G. GEOTEXTILES, RIPRAP OR GABIONS).
- (4) "SWCD" MEANS SOIL AND WATER CONSERVATION DISTRICT.
- (5) "SPDES" MEANS STATE POLLUTION DISCHARGE ELIMINATION SYSTEM.

7/30/21	GEN, PERMIT NOSUBMIT FOR SIGNATURE
11/10/20	SUBMIT FOR SIGNATURE
7/10/18	MAY 15 REVIEW RESPONSE
5/08/18	PLANNING BOARD REVIEW
7/10/2018	Date of Origin
Date	Description

# ESPOSITO & ASSOCIATES

262 GREENWICH AVENUE 605HEN NY,10924 845,294,0558 Fax 845,294,0580

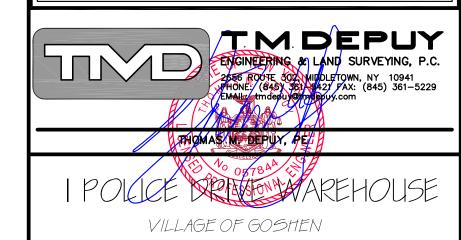


TAX MAP: SEC, 122, BLK, 1, LOT 10,2

### SWPPP GENERAL NOTES AND SPECIFICATIONS

Inauthorized alteration or addition to a plan bearing a Licensed Land Surveyor's c ofessional Engineer's seal is a violation of section 7209, subdivision 2 of the  $N_{
m c}$ State Educational Law.

Scale:	Drawing No.:	Project No.;
NONE	<b>9</b> of <b>1</b> .3	21508,01
TVOTVE	9 % 75	03007R
CAD Reference:	O.C.H.D. Sheet No.;	SWPPP Sheet No,;
03008—SWP01	of	<i>1</i> ∘ <i>5</i>

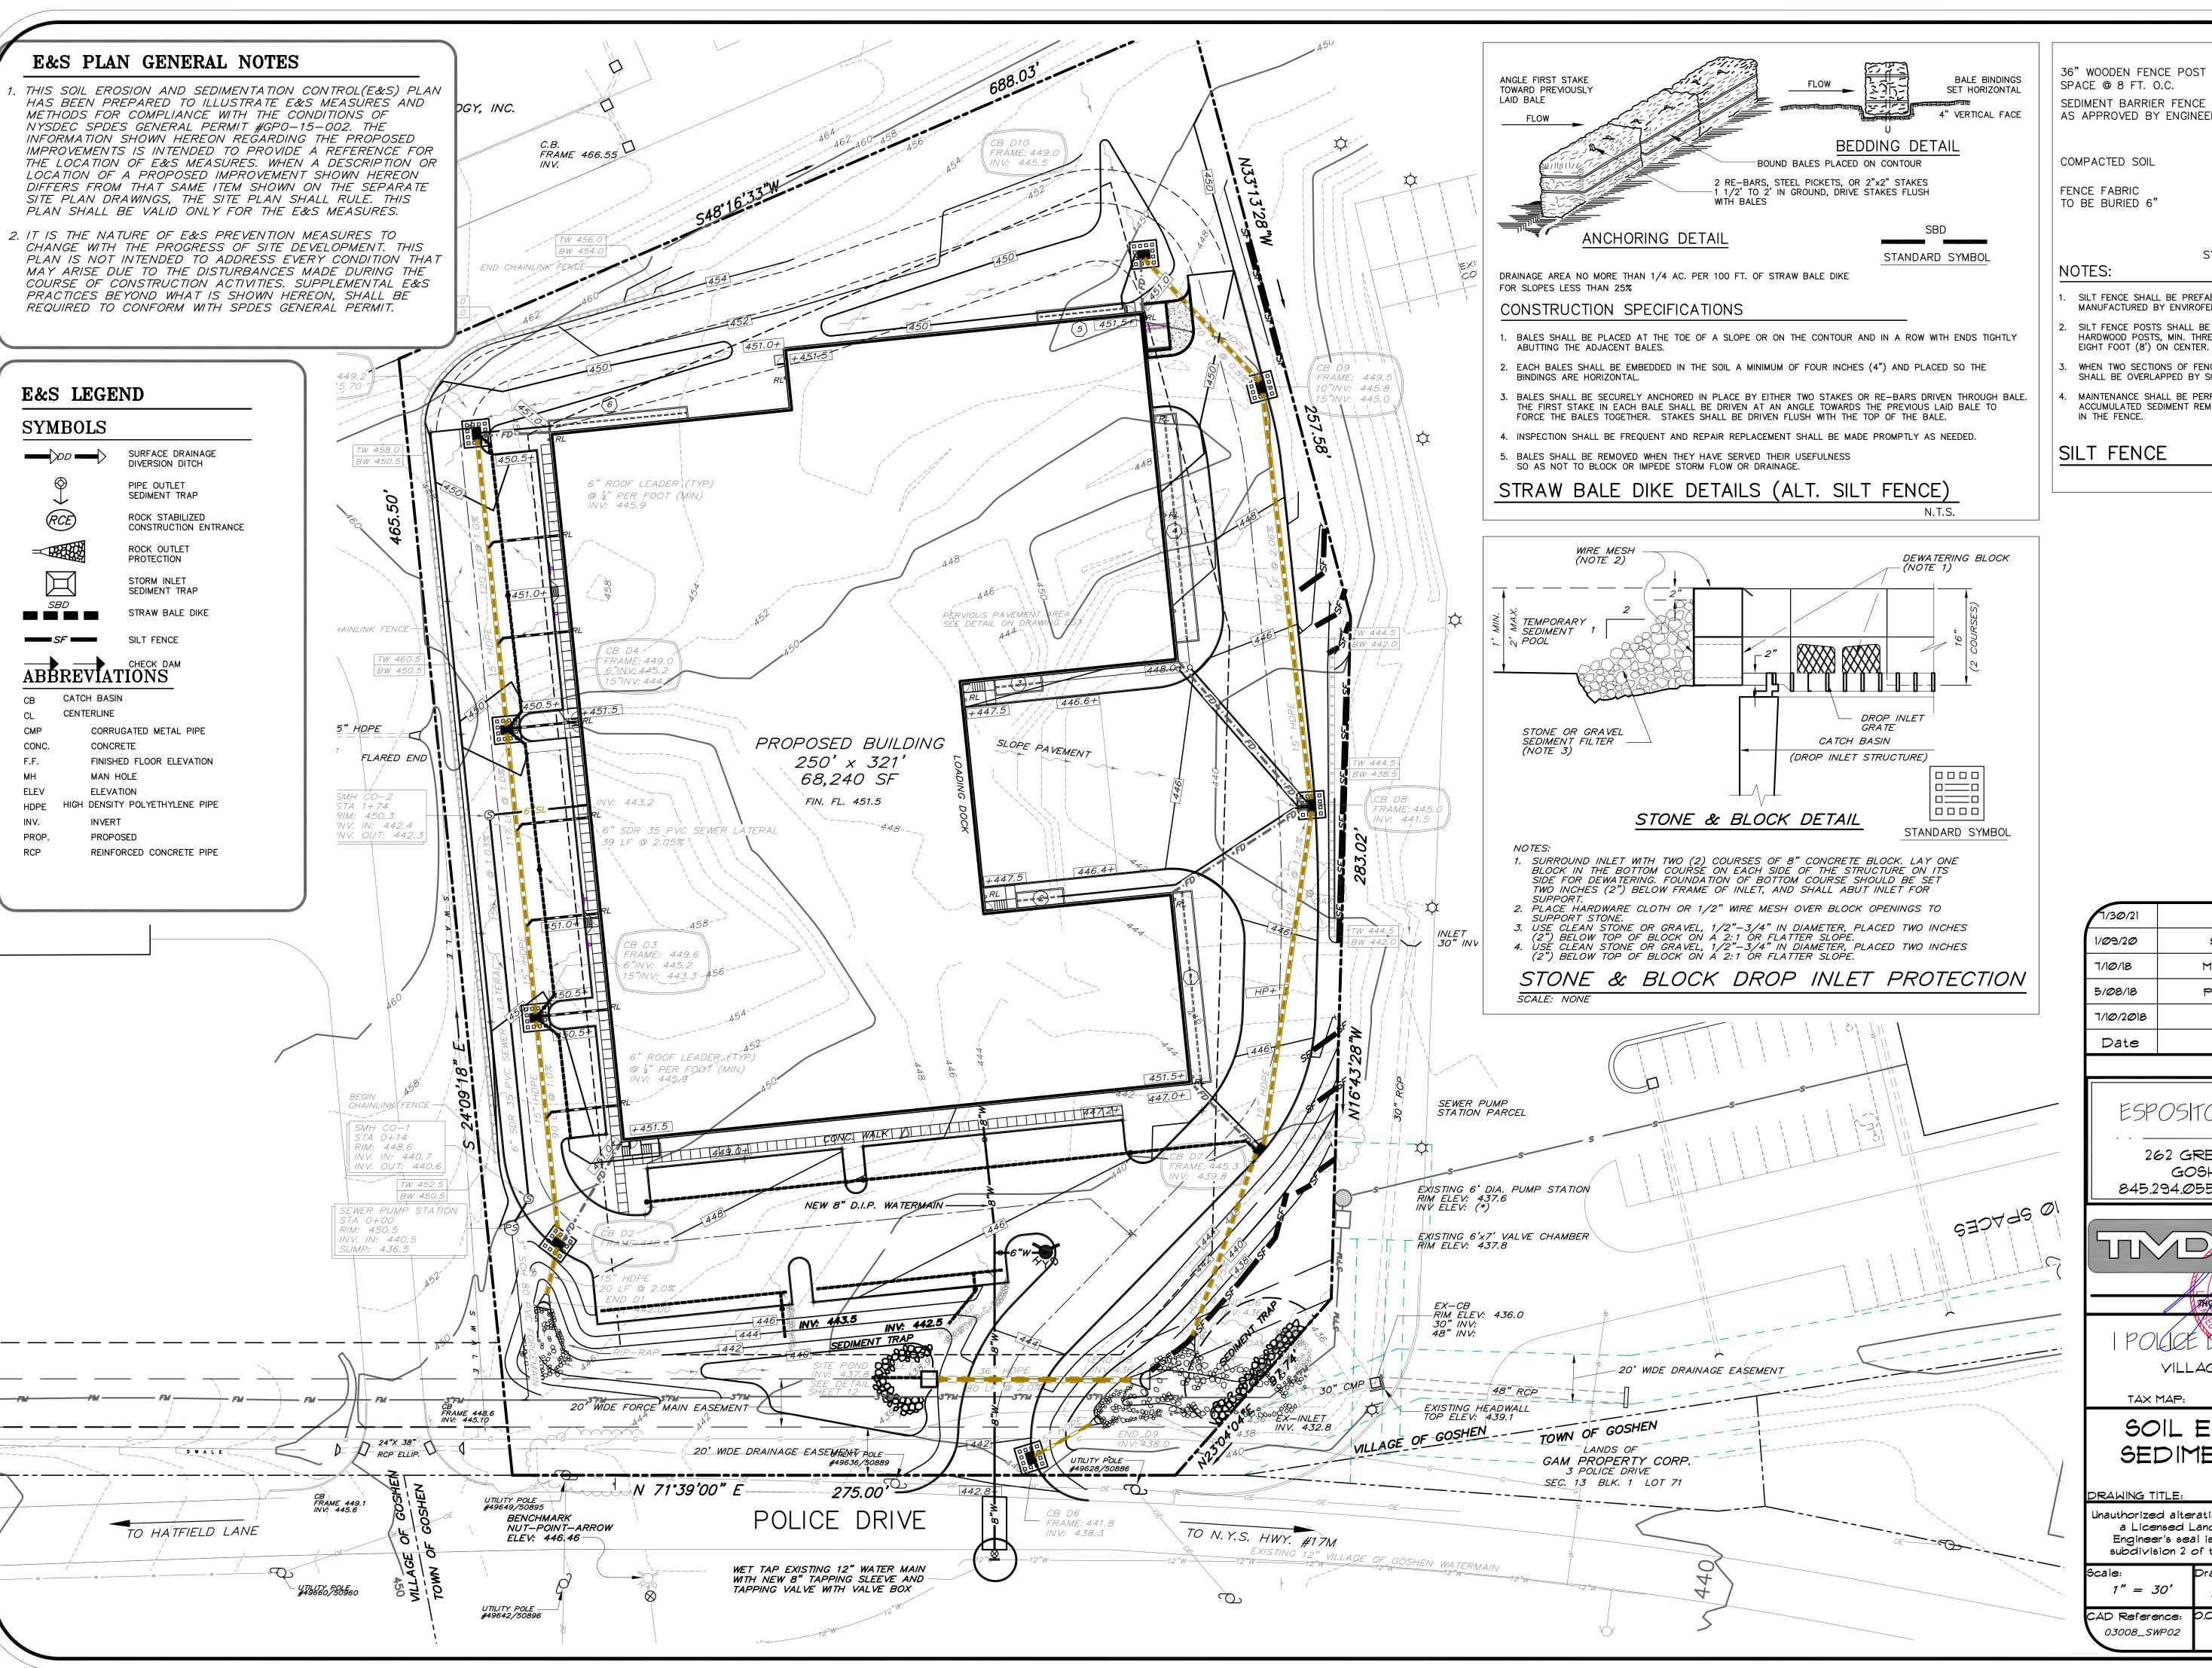

36" WOODEN FENCE POST SPACE @ 8 FT. O.C. SEDIMENT BARRIER FENCE AS APPROVED BY ENGINEER COMPACTED SOIL FENCE FABRIC TO BE BURIED 6"

. SILT FENCE SHALL BE PREFABRICATED FENCE UNITS AS MANUFACTURED BY ENVIROFENCE OR APPROVED EQUAL.

2. SILT FENCE POSTS SHALL BE TWO INCH (2") SQUARE HARDWOOD POSTS, MIN. THREE FOOT (3') LONG, SPACED AT

SYMBOL:

. WHEN TWO SECTIONS OF FENCE ADJOIN EACH OTHER, THEY SHALL BE OVERLAPPED BY SIX INCHES (6") AND FOLDED.


MAINTENANCE SHALL BE PERFORMED AS NEEDED AND ACCUMULATED SEDIMENT REMOVED WHEN "BULGES" DEVELOP

N.T.S.

		_
7/3/2/21	SUBMIT FOR SIGNATURE	
1/09/20	SITE POND REFERENCES	
7/10/18	MAY 15 REVIEW RESPONSE	
5/08/18	PLANNING BOARD REVIEW	
7/10/2018	Date of Origin	
Date	Description	

### ESPOSITO & ASSOCIATES

262 GREENWICH AVENUE GOSHEN NY, 10924 845.294.0558 Fax 845.294.0580

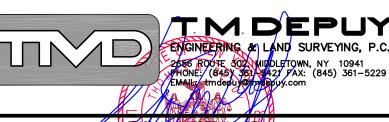


YILLAGE OF GOSHEN

TAX MAP: SEC. 122, BLK. 1, LOT 10.2

## SOIL EROSION AND SEDIMENT CONTROL PLAN

Unauthorized alteration or addition to a plan bearing a Licensed Land Surveyor's or Professional Engineer's seal is a violation of section 7209, subdivision 2 of the NY State Educational Law.

Scale: 1" = 30'	Drawing No.: 10 of 13	Project No.: 21508.01 03007R
CAD Reference:	O.C.H.D. Sheet No.:	SWPPP Sheet
03008_SWP02	0f	No;2 of 5

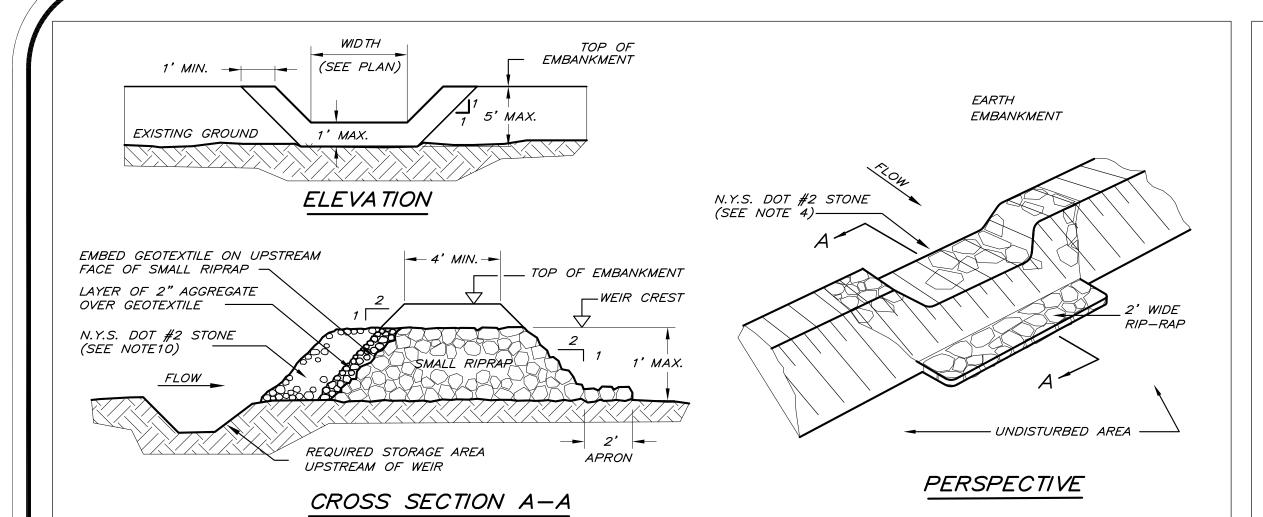


### CONSTRUCTION SPECIFICATIONS

- 1. AREA UNDER EMBANKMENT SHALL BE CLEARED, GRUBBED, AND STRIPPED OF ANY VEGETATION AND ROOT MAT. THE POOL AREA SHALL BE CLEARED.
- 2. THE FILL MATERIAL FOR THE EMBANKMENT SHALL BE FREE OF ROOTS AND OTHER WOODY VEGETATION AS WELL AS OVER—SIZED STONES, ROCKS, ORGANIC MATERIAL OR OTHER OBJECTIONABLE MATERIAL. THE EMBANKMENT SHALL BE COMPACTED BY TRAVERING WITH EQUIPMENT WHILE IT IS BEING CONSTRUCTED.
- 3. ALL CUT AND FILL SLOPES SHALL BE 2:1 OR FLATTER.
- 4. THE STONE USED IN THE OUTLET WEIR SHALL BE SMALL RIPRAP 4"-8" ALONG WITH A 1' THICKNESS OF 2" AGGREGATE PLACED ON THE UP-GRADE SIDE ON THE SMALL RIPRAP OR EMBEDDED FILTER CLOTH IN THE RIPRAP.
- 5. SEDIMENT SHALL BE REMOVED AND TRAP RESTORED TO ITS ORIGINAL DIMENSIONS WHEN THE SEDIMENT HAS ACCUMULATED TO 1/2 THE DESIGN DEPTH OF THE TRAP. IT SHALL BE PLACED ON SITE AND STABALIZED.
- 6. THE STRUCTURE SHALL BE INSPECTED AFTER EACH RAIN AND REPAIRS MADE AS NEEDED.
- 7. CONSTRUCTION OPERATIONS SHALL BE CARRIED OUT IN SUCH A MANNER THAT EROSION AND SEDIMENT ARE CONTROLLED.
- 8. THE STRUCTURE IS PERMANENT OUTLET FOR SEDIMENT FOREBAYS SHOWN ON THE PLANS.
- 9. SUBSTITUTE A ONE (1') FOOT LAYER OF N.Y.S. DOT #2 STONE ( $^3\!4$ ") FOR THE EMBEDDED GEOTEXTILE ON THE UPSTREAM SIDE OF THE SMALL RIPRAP STONE.




# SEDIMENT FOREBAY STONE OUTLET


NOT TO SCALE

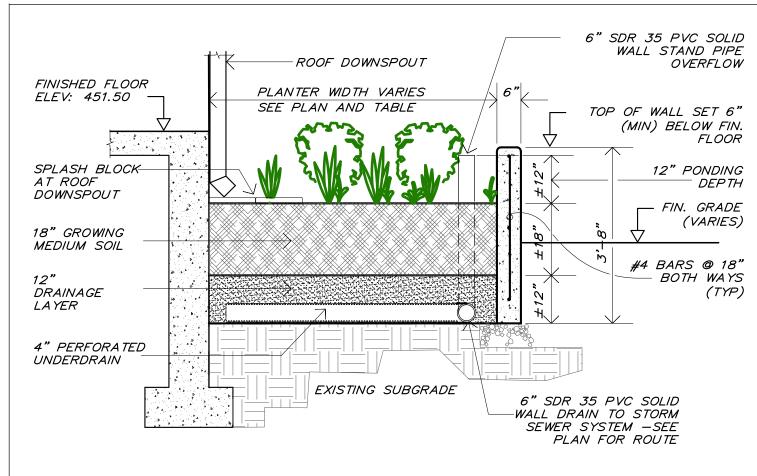

- 1. STORMWATER PLANTERS ARE DESIGNED TO COLLECT AND FILTER RUNOFF FROM THE BUILDING ROOF.
- 2. PLANTER WALLS CAN BE CONSTRUCTED DURING BUILDING ERECTION, AND INSTALLATION OF MEDIA SHALL PROCEED WHEN SITE WORK IS NEAR COMPLETION, JUST PRIOR TO LANDSCAPING.
- 3. GROWING MEDIUM SOIL SHALL BE A UNIFORM MIXTURE OF 70% SAND, 30% TOPSOIL AND 5% COMPOST OR PEAT.
- 4. DRAINAGE LAYER SHALL BE CLEAN SAND MEETING ASTM C33 SPECIFICATIONS.
- 5 NO ROOTS, BRANCHES, WOODY DEBRIS OR CONSTRUCTION WASTE MATERIAL SHALL BE PERMITTED IN THE STORMWATER PLANTER.
- 6. PLANTER TO BE SEEDED WITH NORTHEAST WETLAND DIVERSITY SEED MIX DESCRIBED WITH THE STORMWATER POND DETAIL ON SHEET 5.
- 7. REFER TO LANDSCAPE PLANS FOR ADDITIONAL PLANTING



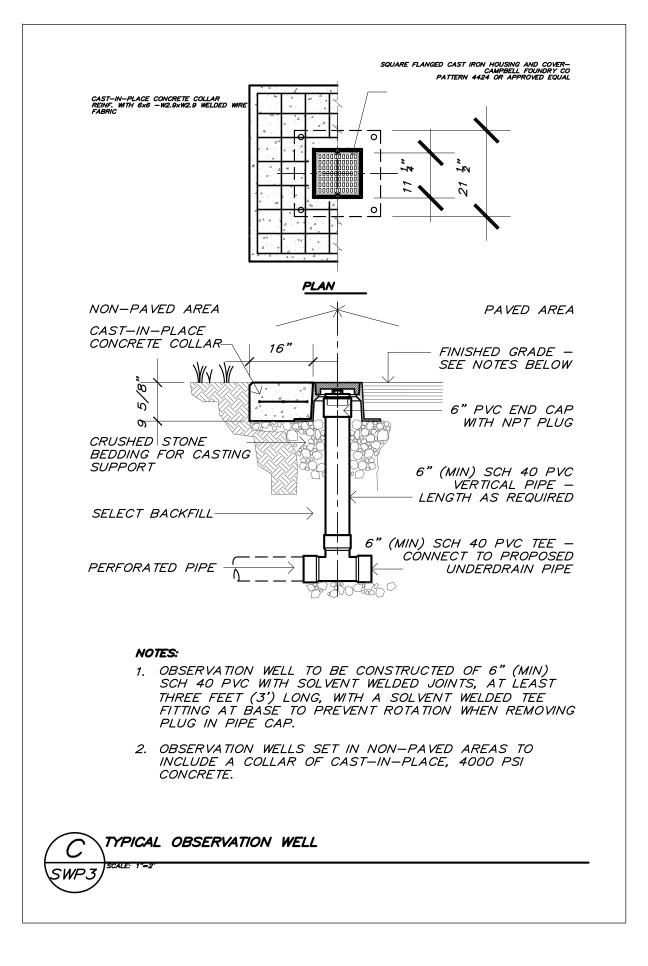

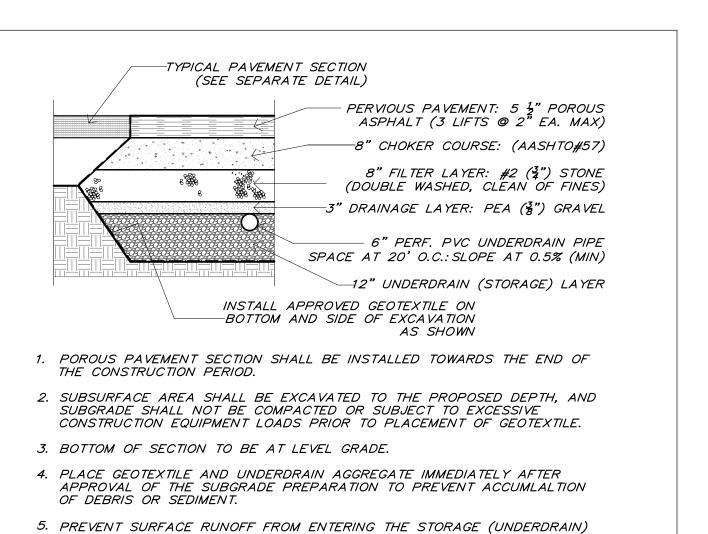



B TYPICAL POROUS PAVEMENT SECTION

SCALE: 1/2" = 1'-0"

BED DURING PLACEMENT OF GEOTEXTILE AND AGGREGATE.




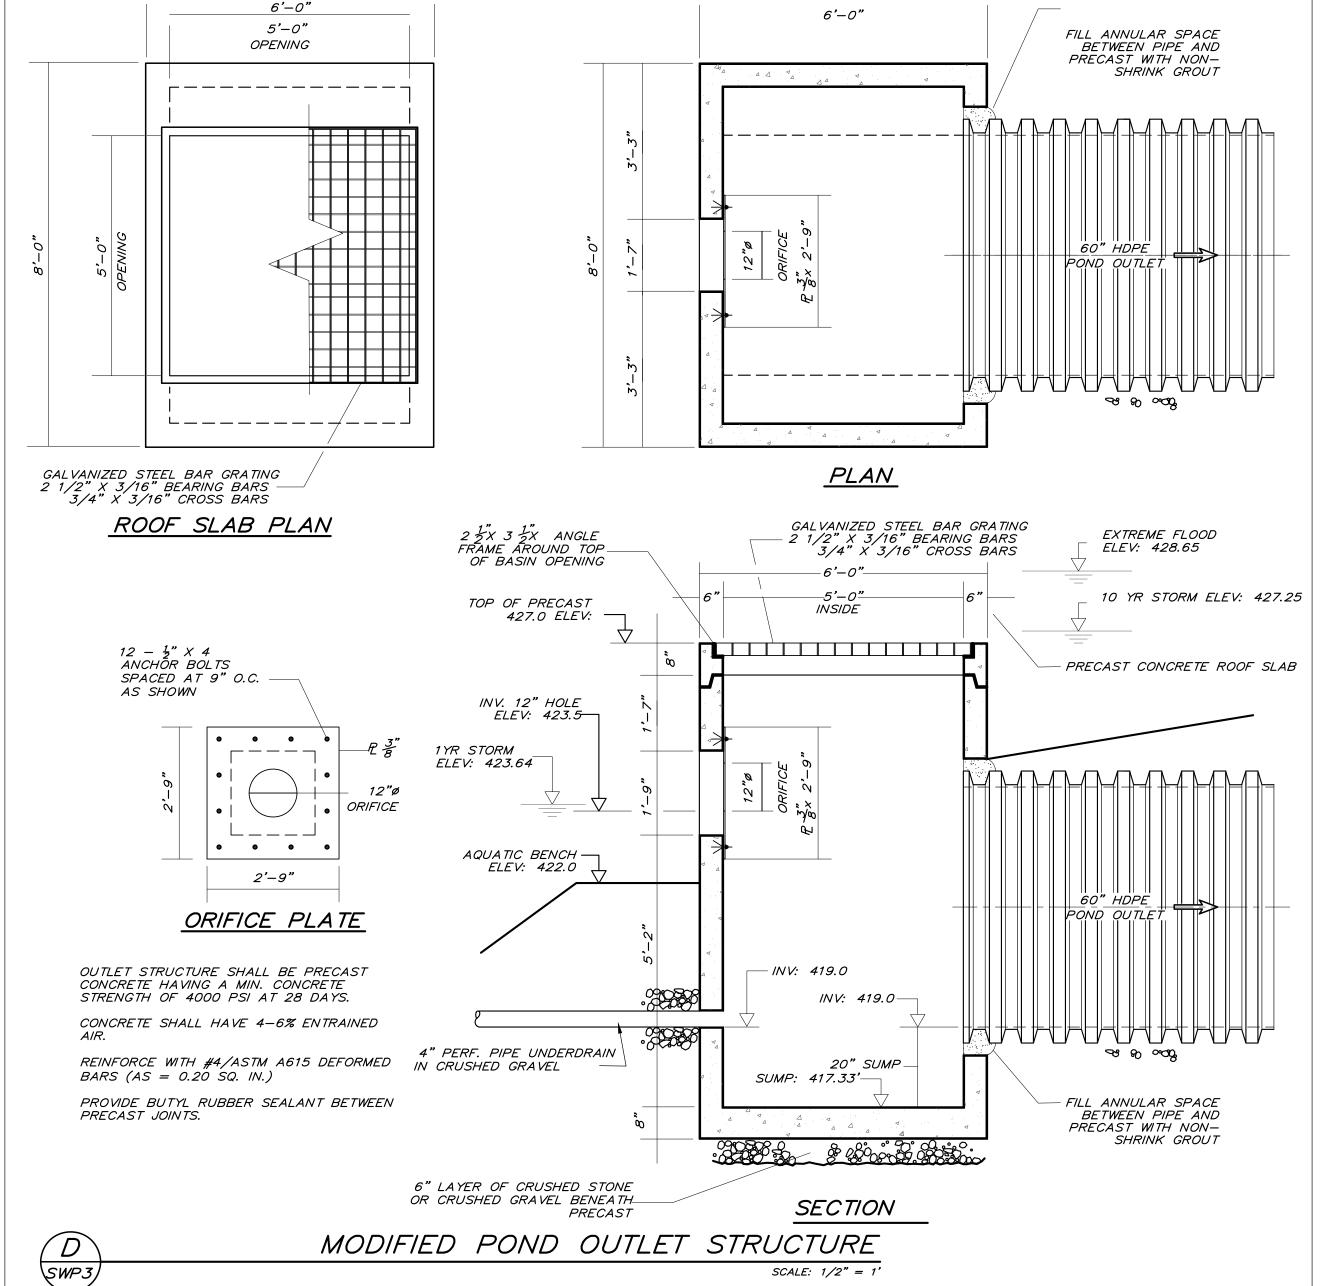

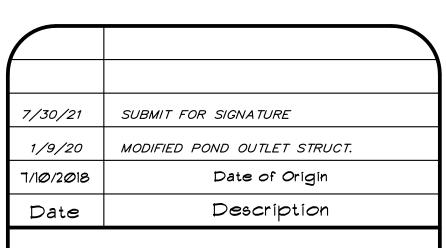

# ESPOSITO & ASSOCIATES

262 GREENWICH AVENUE GOSHEN NY, 10924 845.294.0558 Fax 845.294.0580

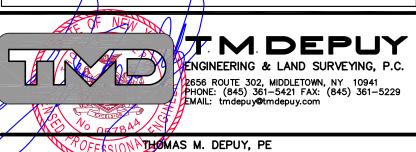

I POLICE DRIVE WAREHOUSE VILLAGE OF GOSHEN

TAX MAP: SEC. 122, BLK. 1, LOT 10.2

## GREEN INFRASTRUCTURE DETAILS

### DRAWING TITLE:

Unauthorized alteration or addition to a plan bearing a Licensed Land Surveyor's or Professional Engineer's seal is a violation of section 7209, subdivision 2 of the NY State Educational Law.

Scale: AS NOTED	Drawing No.: 11 of 13	Project No.: 21508.01 03007R
CAD Reference:	O.C.H.D. Sheet No.:	SWPPP Sheet
03008_SWP03	of	No:3 of 5

